PROJECT RENDERING

SHEET INDEX

DESIGN STUDIO

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681 DRISCOLL CT. PALO ALTO, CA 94306

Monsalve **RESIDENCE**

466 Raquel St. Los Altos, CA 94024


Single-Story Remodel / Addition

AS-101	Drawing No. System Sheet Number Discipline Designator	108 Room Number	Earth	Masonry Unit
Poof Blox	Reference Symbol Title	Window/Skylight Symbol Item Number	Gravel, Rockfill	Metal (omit lines on thin material)
Roof Plan Scale: 144" = 1-07	Reference Number Scale	Door Symbol Item Number	Brick	Finish Wood
X	Exterior Elevation Identification Reference Number Sheet Number	M-101 Millwork Symbol Item Number	Concrete	Wood Framing
X	Section Indentification Reference Number	Appliance Symbol Appliance Type Item Number	Sand, Mortar, Plaster, Gyp. Bd.	Wood Blocking
XXX	— Sheet Number Detail Identification	Fixture/Fitting Symbol Item Number	Stone (including Marble)	Plywood
— XXXX	Reference Number Sheet Number	Louver Symbol Item Number	Insulation	Backer Board
D XXX B	Interior Elevation Identification Drawing Number Sheet Number	Accessory Symbol Item Number		2'-0" Dimensions 2'-0" Center Line Dimension
·	Datum Point	Revision Cloud Revision Number	Center Line	2'-0" Face of Finish Dimension

EXISTING	PROPOSED	ALLOWED/REQ'D
3,525.0 SF (27.2%)	3,525.0 SF (27.2%)	4,530.5 SF (35%)
•		4,530.5 SF
` '	,	(35%)
		850 SF
(0.0%)	(96.2%)	(100%)
25'-6"	25'-6"	25'
9'-8"	9'-8"*	25'
11'-2"	10'-2"	10'
10'-4"	10'-4"	10'
15'-8"	20'	20'
		
	3,525.0 SF (27.2%) 3,525.0 SF (27.2%) 0.0 SF (0.0%) 25'-6" 9'-8" 11'-2" 10'-4"	3,525.0 SF (27.2%) 3,525.0 SF (27.2%) 3,525.0 SF (0.0%) 0.0 SF (0.0%) 0.0 SF (96.2%) 25'-6" (96.2%) 25'-6" (9'-8" (10'-2" (10'-4") (10'-4")

- * EXISTING NON-CONFORMING TO REMAIN
- ** ALL HEIGHT MEASURED FROM EXISTING GRADE TO ROOF PEAK

PARCEL MAP

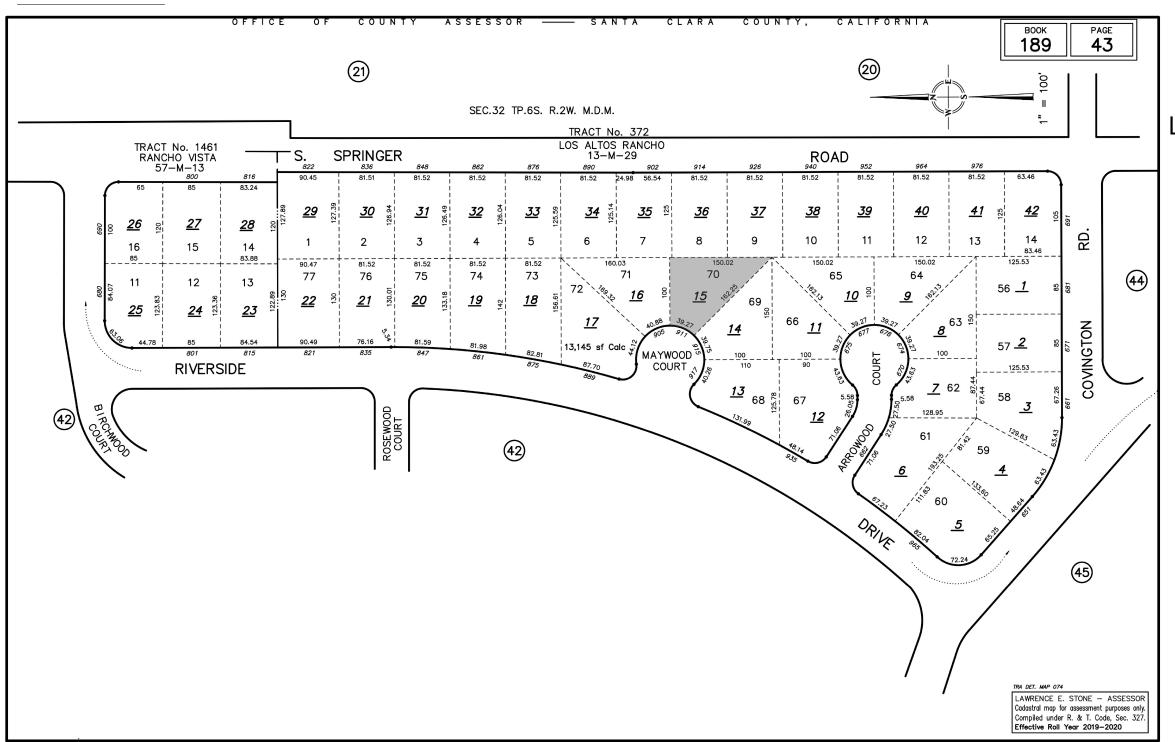

SQUARE FOOTAGE BREAKDOWN

	EXISTING	CHANGE	PROPOSED
HABITABLE LIVING:	2,185.1 SF	-173.8 SF	2,011.3 SF
NON-HABITABLE LIVING:	1,339.9 SF	+173.8 SF	1,513.7 SF
ADU HABITABLE LIVING:	0.0 SF	0.0 SF	646.3 SF
ADU NON-HABITABLE LIVING:	0.0 SF	0.0 SF	171.8 SF

LOT CALCULATIONS

12,944.3 SF NET LOT AREA: 2,330.5 SF FRONT YARD AREA:

FRONT YARD HARDSCAPE: 535.6 SF (23.0%) (EXISTING TO REMAIN)

PROJECT DESCRIPTION

REMODEL / ADDITION OF EXISTING SINGLE-STORY HOUSE. REMODEL TO FIRST FLOOR GARAGE, ENTRY DOOR, LAUNDRY ROOM, AND BATHROOM.

ADDITION OF SECOND FLOOR ADU AND ASSOCIATED STAIRCASE.

CODE COMPLIANCE

2019 California Building Code 2019 California Residential Code 2019 California Plumbing Code 2019 California Mechanical Code 2019 California Electrical Code 2019 California Energy Code 2019 California Green Building Standards 2019 California Fire Code

A0.0	Cover Sheet
A0.1	Notes
AN1.1	Neighborhood Context Map & Elevations
SU1	Topgraphic Survey
AS1.1	Architectural Site Plan
AX1.1	Area Calcs & Conditions of Approval from Los Altos
A1.1	Demolition Floor Plan
A1.2	Demolition Roof Plan
A1.3	Existing Exterior Elevations
A1.4	Existing Exterior Elevation & Section
A2.1	Floor Plan
A2.2	Second Floor Plan - ADU Plan
A2.3	Roof Plan
A3.1	Reflected Ceiling Plan
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Exterior Elevations

Door/Window Schedule

Sections

PROJECT TEAM

DESI	IGNER:
KNR	Design Studio
Kend	ra Rosenberg
681 E	Oriscoll Ct.
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STRUCTURAL:

LANDSCAPE ARCHITECT: T.B.D.

GENERAL CONTRACTOR: T.B.D.
TITLE 24: T.B.D.
INTERIOR DESIGNER: T.B.D.

ARBORIST:

Issues and Revisions 10/15/21 Planning Submittal **Project** MONSALVE RESIDENCE **Date** 16.AUG.2021 Scale N.T.S.

Sheet Cover Sheet

PLUMBING NOTES

- 1. ALL PLUMBING ITEMS ARE SHOWN SCHEMATICALLY AND INSTALLATIONS SHALL BE REVIEWED BY THE BUILDING INSPECTOR IN THE FIELD.
- 2. PROVIDE R-3 OR BETTER INSULATION ON ALL PIPING. ISOLATE ALL PIPING WITH RUBBER GROMMETS. PROVIDE AN R-12 OR GREATER EXTERNAL BLANKET AROUND WATER HEATER.
- 3. ALL WASTE LINES TO BE CAST IRON WITHIN STRUCTURE. PLASTIC WASTE LINES ARE ACCEPTABLE BELOW STRUCTURE.
- 4. ALL FLUES AND VENTS PENETRATING THE ROOF SHALL MAKE TRANSITIONS OR BENDS SO THAT THEY PENETRATE THE BACK OF THE ROOF AND DO NOT EXTEND BEYOND THE PEAK OF THE ROOF. TERMINATIONS OF ALL FLUES AND VENTS SHALL BE LOCATED REQUIRED DISTANCES ABOVE AND/OR AWAY FROM OPERABLE DOORS, WINDOWS, AND SKYLIGHTS. COORDINATE WITH ARCHITECT.
- 5. ALL PLUMBING CLEANOUTS SHALL BE LOCATED WITHIN 20 FT. OF A CRAWLSPACE ACCESS POINT OR WILL BE RUN TO THE NEAREST OUTSIDE WALL.
- 6. PROVIDE PERMANENT IDENTIFICATION ON AL LSHUT-OFF VALVES (GAS & WATER).
- 7. PROVIDE APPROVED NON-REMOVABLE BACKFLOW PREVENTION DEVICES AT ALL HOSE RIPS
- 8. IF PRESSURE REGULATOR OR ANY DEVICE THAT PREVENTS PRESSURE RELIEF THROUGH THE BUILDING SUPPLY IS INSTALLED, AN EXPANSION TANK IS REQUIRED FOR THE WATER TANK.
- 9. PROVIDE A TEMPERATURE AND PRESSURE RELIEF VALVE AT EACH WATER HEATER WITH A FLOOR DRAIN IN THE MECHANICAL ROOM CONNECTED TO THE OUTSIDE WALL AS SHOWN ON THE DRAWINGS.
- 10. INSULATE PIPE IN ACCORDANCE WITH CMC AND TITLE 24 REQUIREMENTS.
- 11. PROVIDE SEISMIC STRAPPING AT WATER HEATER.
- 12. ALL TOILETS TO BE LOW-FLOW (MAX. 1.28 GALLONS PER FLUSH PER CPC 402.2).
- 13. ALL SHOWERS AND SHOWER/TUB COMBINATIONS SHALL BE PROVIDED WITH INDIVIDUAL CONTROL VALVES OF THE THERMAL MIXING OR PRESSURE BALANCE TYPE.
- 14. WHERE 4 OR MORE WATER CLOSETS ARE INSTALLED, THE BUILDING DRAIN SHALL BE A MINIMUM 4 INCHES DIAMETER.
- 15. THE MAXIMUM HOT WATER TEMPERATURE DISCHARGING FROM A BATHTUB OR WHIRLPOOL BATHTUB SHALL BE LIMITED TO 120 DEGREES FAHRENHEIT. THE WATER HEATER THERMOSTAT SHALL NOT BE CONSIDERED A CONTROL FOR MEETING THIS PROVISION.
- 16. INDOOR WATER USE SHALL BE REDUCED BY AT LEAST 20% BY USING WATER SAVING FIXTURES OR FLOW RESTRICTOR, OR DEMONSTRATE A 20% REDUCTION ON BASELINE WATER USE PER SECTION 4.303.1. REFER TO PLUMBING FIXTURE/FITTING SCHEDULES ON SHEET M-102 FOR WATER SAVING FIXTURES SPECIFIED.
- 17. PROVIDE A CLEANOUT AT THE KITCHEN SINK WITHIN 2'-0" OF THE FOUNDATION WALL.
- 18. PROVIDE WATER HAMMER ARRESTER, ASSE 1010-2004 AT BUILDING SUPPLY WATER LINES WHERE QUICK ACTING VALVES ARE INSTALLED PER CPC 609.10. INSTALL AS CLOSE TO THE QUICK ACTING VALVE AS POSIBLE, PER MFR SPECIFICATIONS, INCLUDING, BUT NOT LIMITED TO DISHWASHER AND CLOTHES WASHER SUPPLY VALVES.
- 19. ALL PLUMBING VENTS SHALL (PER CPC 906):
 BE A MINIMUM 3'-0" ABOVE OR 10'-0" AWAY FROM OPERABLE SKYLIGHTS, OPERABLE WINDOWS, DOORS, OPENINGS, AIR INTAKES, OR VENT SHAFTS.
- -- BE A MINIMUM OF 3' FROM PROPERTY LINE.
 -- TERMINATE NOT LESS THAN 6" ABOVE THE ROOF, NOR LESS THAN 1' FROM ANY
- VERTICAL SURFACE.
- 20. A DEDICATED FUEL SHUT-OFF VALVE SHALL BE INSTALLED WITHIN 6 FEET OF THE GAS APPLIANCE IT SERVES. (CPC 1212.5 and CMC 1313.4)
- 21. A SEDIMENT TRAP SHALL BE PROVIDED ON THE GAS LINE DOWNSTREAM OF THE APPLIANCE SHUT-OFF VALVE, AS CLOSE TO THE INLET OF THE EQUIPMENT AS PRACTICAL, AND UPSTREAM OF THE FLEX CONNECTOR. (CPC 1212.8)

MECHANICAL NOTES

- 1. ALL MECHANICAL ITEMS ARE SHOWN SCHEMATICALLY, AND INSTALLATION SHALL BE REVIEWED BY THE BUILDING INSPECTOR IN THE FIELD.
- 2. THE TITLE 24 REPORT ENTITLED 'ENERGY COMPLIANCE REPORT', INCLUDING HEAT LOSS CALCULATIONS, IS PART OF THE CONSTRUCTION DOCUMENTS. THE MECHANICAL CONTRACTOR SHALL SUBMIT FOR THE DESIGNER' APPROVAL ALL DRAWINGS, SPECIFICATIONS, PRODUCT LITERATURE AND CALCULATIONS THAT ARE PART OF THE HEATING SYSTEM. ALL WORK MUST COMPLY WITH THE TITLE 24 REPORT AND ALL OTHER APPLICABLE CODES AND ORDINANCES.
- 3. THE HEATING SYSTEM WILL BE DONE ON A DESIGN/BUILD BASIS. DUCTS AND RISERS SHALL BE GALV. SHEET METAL, PER SMACNA STANDARDS, UNLESS OTHERWISE NOTED. FLEXIBLE DUCTS TO REGISTERS ARE ACCEPTABLE, PROVIDED THAT LENGTH DOES NOT EXCEED 12'-0". PROVIDE ISOLATION OF DUCTS FROM WALLS AND ADJACENT DUCTWORK. INSULATE DUCTWORK IN ACCORDANCE WITH CMC 602.2.
- 4. THE HOUSE WILL BE HEATED BY GAS-FIRED FURNACES. PROVIDE ZONES AS SHOWN ON THE DRAWINGS. PROVIDE DAMPERS AT REGISTERS. PROVIDE PROGRAMMABLE ELECTRIC THERMOSTATS, TO BE APPROVED BY OWNER. THERMOSTATS SHALL BE 48" A.F.F. SEE DRAWINGS FOR LOCATIONS.
- 5. THE GENERAL CONTRACTOR SHALL ENSURE THAT THE LOCATIONS OF ALL DUCTS, REGISTERS AND GRILLES COORDINATE WITH ALL TRADES. DUCT, PIPE AND WIRING SHALL BE ROUTED TO CLEAR ARCHITECTURAL OPENINGS, STRUCTURAL MEMBERS, OR OTHER
- 6. ALL FLUES AND VENTS PENETRATING THE ROOF SHALL MAKE TRANSITIONS OR BENDS SO THAT THEY PENETRATE THE BACK OF THE ROOF AND DO NOT EXTEND BEYOND THE PEAK OF THE ROOF. TERMINATIONS OF ALL FLUES AND VENTS SHALL BE LOCATED REQUIRED DISTANCES ABOVE AND/OR AWAY FROM OPERABLE DOORS, WINDOWS AND SKYLIGHTS. COORDINATE WITH DESIGNER.
- 7. IN LIEU OF REQUIRED EXTERIOR OPENINGS FOR NATURAL VENTILATION IN APPLICABLE HABITABLE ROOMS, THE MECHANICAL SYSTEM SHALL BE CAPABLE OF PROVIDING TWO (2) AIR CHANGES PER HOUR AND 15 CUBIC FEET PER MINUTE OF OUTSIDE AIR PER OCCUPANT.
- 8. IN LIEU OF REQUIRED EXTERIOR OPENINGS FOR NATURAL VENTILATION IN APPLICABLE BATHROOMS, AND SIMILAR ROOMS, A MECHANICAL SYSTEM CONNECTED DIRECTLY TO THE OUTSIDE CAPABLE OF PROVIDING FIVE (5) AIR CHANGES PER HOUR SHALL BE PROVIDED. SUCH SYSTEM SHALL BE CONNECTED DIRECTLY TO THE OUTSIDE, AND THE POINT OF DISCHARGE SHALL BE AT LEAST 3 FEET FROM ANY OPENING THAT ALLOWS AIR ENTRY INTO OCCUPIED PORTIONS OF THE BUILDING.
- 9. PROVIDE CONDENSATE DRAINS AT FURNACES.
- 10. IF REQUIRED SOURCE OF COMBUSTION AIR FOR FURN-2 SHALL BE PROVIDED FROM 2 ROOF VENTS LOCATED ONE HIGH WITHIN 12" OF THE TOP OF THE ATTIC SPACE AND ONE LOW WITHIN 12" OF THE TOP OF THE CEILING JOISTS IN THE ATTIC SPACE WHERE THE FURNACE WILL BE LOCATED. SEE ROOF PLAN FOR LOCATIONS.
- 11. SYSTEM INSTALLERS MUST BE TRAINED AND CERTIFIED, AND SPECIAL INSPECTORS EMPLOYED BY THE ENFORCING AGENCY MUST BE QUALIFIED.
- 12. COVERING OF DUCT OPENINGS AND PROTECTION OF MECHANICAL EQUIPMENT DURING CONSTRUCTION. AT THE TIME OF ROUGH INSTALLATION, DURING STORAGE ON HE CONSTRUCTION SITE, AND UNTIL FINAL STARTUP OF THE HEATING, COOLING, AND VENTILATING EQUIPMENT, ALL DUCT AND OTHER RELATED AIR DISTRIBUTION COMPONENT OPENINGS SHALL BE COVERED WITH TAPE, PLASTIC, SHEET METAL, OR OTHER METHODS ACCEPTABLE TO THE ENFORCING AGENCY TO REDUCE THE AMOUNT OF WATER, DUST AND DEBRIS, WHICH MAY ENTER THE SYSTEM.
- 13. ATTIC EQUIPMENT SHALL HAVE:
- -- AN ACCESSIBLE OPENING OF NOT LESS THAN 22" BY 30" OR THE AT LEAST AS LARGE AS THE LARGEST SINGLE COMPONENT OF THE UNIT
- -- THE PASSAGEWAY TO THE UNIT IS NOT MORE THAN 20 FEET AWAY MEASURED ALONG THE CENTERLINE OF THE PASSAGEWAY (WHEN THE CLEAR HEIGHT IS LESS THAN 6 FEET).
- SHALL HAVE A SOLID FLOORING NOT LESS THAN 24" WIDE
 A LEVEL WORKING PLATFORM NOT LESS THAN 30" BY 30" IN FRONT OF THE UNIT

HAVE A CLEAR HEIGHT AT THE ACCESS OPENING OF AT LEAST 30". PER CBC

- -- A PERMANENT 120V RECEPTACLE OUTLET NEAR THE EQUIPMENT
 -- A LIGHT FIXTURE LOCATED AT THE ENTRANCE TO THE PASSAGEWAY
- 14. PROVIDE EXHAUST FANS AT ALL BATHROOMS, POWDER ROOMS AND WATER CLOSETS.
- 15. LOCATE RETURN AIR GRILLES ON WALL NEAR CEILING OR ON CEILING AS SHOWN ON
- PLANS, U.O.N.

16. COORDINATE LOCATIONS OF ALL GRILLES WITH REFLECTED CEILING PLANS, FINISH

- PLANS, & INTERIOR ELEVS.

 17. PROVIDE DAMPERS AS REQUIRED FOR ZONES & ROOM SIZES. PROVIDE REQUIRED
- ACCESS TO DAMPER MOTORS THROUGH ACCESS PANELS.
- 18. INSTALL TANKLESS WATER HEATER PER CPC AND MANUFACTURERS RECOMMENDATIONS.19. VERIFY LOCATION OF DUCTWORK HOLES WITH ENGINEER. AT ALL SHEAR WALL

ELECTRICAL NOTES

- 1. ELECTRICAL CONTRACTOR SHALL DEVELOP ROUGH WIRING FOR ALL ELECTRICAL ELEMENTS SHOWN ON THE DRAWINGS. LOAD DATA WILL BE BASED ON THE DIAGRAMMATIC PLANS. ELECTRICAL CONTRACTOR SHALL VERIFY THAT EXISTING WIRING IS SAFE AND UP TO THE CURRENT CODES.
- 2. ELECTRICAL SYSTEM SHALL FOLLOW CURRENT EDITION OF THE CEC.
- 3. MINIMUM WIRE SIZE SHALL BE #12 AWG, EXCLUDING CONTROL WIRING. UNLESS OTHERWISE NOTED, ALL CONDUCTORS SHALL BE COPPER.
- ELECTRICAL CONTRACTOR SHALL TURN OVER TO THE OWNER AT THE COMPLETION OF THE JOB AN AS-BUILT DIAGRAM ON A BLUE PRINT SHOWING THE CIRCUITING, CIRCUIT NUMBERS AND ELECTRICAL LAYOUT.
- 5. ELECTRICAL CONTRACTOR SHALL SUPPLY A PANEL BOARD DIRECTORY AT THE PANEL AT THE COMPLETION OF THE JOB.
- 6. ELECTRICAL CONTRACTOR SHALL INSTALL ALL DEVICES AND LIGHT FIXTURES. SEE FIXTURE SCHEDULE.
- 7. ALL ELECTRICAL EQUIPMENT AND DEVICES SHALL BEAR A UL LABEL.
- 8. ALL NEW TELEPHONE OUTLETS SHALL BE MIN. THREE-LINE, U.O.N.; TO BE LOCATED AS REQUESTED BY OWNER.
- PROVIDE WIRING FOR COMPUTER NETWORKING; TO BE LOCATED AS REQUESTED BY OWNER.
- 10. PROVIDE APPROVED UFER GROUND SYSTEM, MIN. 20 FT NO. 4 OR GREATER BARE COPPER CONDUCTOR, BELOW VAPOR BARRIER, FULLY ENCASED WITHIN THE FOOTINGS OR PIERS AND GRADE BEAMS. COORDINATE WITH G.C. AND CONCRETE CONTRACTOR.
- 11. CLEAR WORKING SPACE IS REQUIRED AT ALL ELECTRICAL PANELS, WORKING SPACE AT THE FRONT OF ELECTRICAL EQUIPMENT:
- -- SHALL HAVE A MINIMUM DEPTH OF 36 INCHES, WIDTH OF 30 INCHES, AND HEIGHT OF 6 FEET 6 INCHES.
 -- SHALL HAVE AT LEAST ONE ENTRANCE OF 24 INCHES WIDE BY 6 FEET 6 INCHES HIGH.
- -- SHALL NOT BE USED FOR STORAGE.
 -- ILLUMINATION SHALL BE PROVIDED FOR ALL WORKING SPACES ABOUT SERVICE EQUIPMENT, SWITCHBOARDS, PANEL BOARDS, OR MOTOR CONTROL CENTERS INSTALLED INDOORS.
- 12. PROVIDE GFCI PROTECTION TO ALL 120 VOLT, SINGLE-PHASE, 15- AND 20- AMP RECEPTACLES INSTALLED: kitchens, bathrooms, laundry areas, outdoors, garages, unfinished basements, crawl spaces, and accessory buildings at or below grade not intended as habitable rooms and limited to storage areas, work areas, and areas of similar use.
- 13. PROVIDE AFCI PROTECTION TO ALL 120 VOLT, SINGLE-PHASE, 15- AND 20- AMP BRANCH CIRCUITS SUPPLYING OUTLETS OR DEVICES INSTALLED IN: kitchens, family rooms, dining rooms, living rooms, parlors, libraries, dens, bedrooms, sunrooms, recreation rooms, closets, hallways, laundry areas, or similar rooms or areas. THEY SHALL BE PROTECTED BY ANY OF THE MEANS DESCRIBED IN 210.12(A)(1) THROUGH (6).
- 14. KITCHEN RECEPTACLES:
- -- INSTALL AT LEAST ONE OUTLET ON THE END OF ANY KITCHEN ISLANDS TO COMPLY WITH ARTICLE 210.52 (C) 4 CEC.
- -- AT THE KITCHEN SINK, INSTALL A GFCI PROTECTED RECEPTACLE WITHIN 24" PER ARTICLE 210.50 (C) 1 CEC.
- -- ALL ABOVE COUNTER RECEPTACLES IN THE KITCHEN SHALL NOT EXCEED 4 FEET ON CENTER AND GFCI PROTECTED.
- PROVIDE A RECEPTACLE FOR EACH COUNTER SPACE 12 INCHES OR WIDER SO THAT NO POINT IS MORE THAN 24" FROM AN OUTLET
- 15. ALL PERMANENTLY INSTALLED LIGHTING SHALL BE HIGH EFFICACY.
- 16. ALL RECESSED CAN LIGHTING TO BE IC/AT RATED.
- 17. PERMANENTLY INSTALLED LUMINAIRES IN GARAGES, LAUNDRY ROOMS AND UTILITY ROOMS SHALL BE HIGH EFFICACY LUMINAIRES AND CONTROLLED BY OCCUPANCY SENSORS.
- 18. PERMANENTLY INSTALLED LUMINAIRES IN BATHROOMS SHALL BE HIGH EFFICACY LUMINAIRES AND CONTROLLED BY VACANCY SENSORS.
- 19. PERMANENTLY INSTALLED LUMINAIRES LOCATED OTHER THAN IN KITCHENS, BATHROOMS, GARAGE, LAUNDRY ROOMS AND UTILITY ROOMS SHALL BE HIGH EFFICACY LUMINAIRES (EXCEPT CLOSETS LESS THAN 70 SF) AND CONTROLLED BY A DIMMER SWITCH OR BY VACANCY SENSORS THAT DO NOT TURN ON AUTOMATICALLY OR HAVE AN ALWAYS-ON OPTION.
- 20. LUMINAIRES PROVIDING OUTDOOR LIGHTING AND PERMANENTLY MOUNTED TO A RESIDENTIAL BUILDING, OR TO OTHER BUILDINGS ON THE SAME LOT, SHALL BE HIGH EFFICACY LUMINAIRES AND CONTROLLED BY A MANUAL ON AND OFF SWITCH AND ONE OF THE FOLLOWING PER CENC 150.0(K)3:
- PHOTOCELL AND MOTION SENSORPHOTOCONTROL AND AUTOMATIC TIME SWITCH CONTROL

OF WALLS OR OPENINGS.

- -- AUTOMATIC TIME CLOCK
- -- ENERGY MANAGEMENT CONTROL SYSTEM
- 21. SMOKE ALARMS ARE REQUIRED AT THE FOLLOWING AREAS:
- ONE ON EACH FLOOR LEVEL
 IN THE ADJACENT ROOM (OR AREA) WHERE THE CEILING HEIGHT EXCEEDS THAT OF THE HALLWAY BY 24 INCHES.
- 22. FOR NEW CONSTRUCTION, ALL SMOKE & CARBON MONOXIDE ALARMS SHALL BE HARDWIREDAC/DC TO 110V WITH A BATTERY BACKUP AND SHALL BE INTERCONNECTED.
- 23. PROVIDE ONE SWITCHED LIGHT FIXTURE OR SWITCH-CONTROLLED OUTLET INSTALLED IN HALLWAYS, STAIRWAYS, ATTACHED GARAGES AND DETACHED GARAGES WITH ELECTRICITY.

24. PROVIDE AT LEAST ON WALL SWITCH-CONTROLLED LIGHTING OUTLET INSTALLED TO

- PROVIDE ILLUMINATION ON THE EXTERIOR SIDE OF OUTDOOR ENTRANCES OR EXITS WITH GRADE LEVEL ACCESS.

 25. PROVIDE OUTSIDE GFCI PROTECTED WEATHERPROOF 120-VOLT RECEPTACLE AT EACH
- SIDE OF UNIT, INSTALLED WITHIN 6 FEET 6 INCHES OF GRADE.

 26. ALL 125-VOLT, 15 AND 20 AMPERE RECEPTACLE OUTLETS SHALL BE LISTED
- TAMPER-RESISTANT RECEPTACLES PER CEC 406.11, INCLUDING BUT NOT LIMITED TO DISHWASHER, LAUNDRY, & GARBAGE DISPOSAL.

 27. RECEPTACLES INSTALLED OUTDOORS IN A WET LOCATION SHALL HAVE AN ENCLOSURE
- THAT IS WEATHERPROOF WHETHER OR NOT THAT ATTACHMENT PLUG CAP IS INSERTED.

 28. PROVIDE A RECEPTACLE OUTLET IF THE WALL IS 2 FEET WIDE OR GREATER. OUTLETS SHALL BE SPACED NO MORE THAN 12 FEET APART AND A MAXIMUM OF 6 FEET FROM END
- 29. PROVIDE ONE ELECTRICAL OUTLET IN HALLWAYS OVER 10 FT IN LENGTH.
- 30. PROVIDE A WALL RECEPTACLE OUTLET IN BATHROOMS WITHIN 36 INCHES OF THE OUTSIDE EDGE OF EACH BASIN COMPLYING WITH THE FOLLOWING CODE MINIMUMS
- THE OUTLET SHALL BE LOCATED ON A WALL THAT IS ADJACENT TO THE BASIN LOCATION.
 RECEPTACLES SHALL NOT BE INSTALLED IN A FACE-UP POSITION IN COUNTERS OR SIMILAR WORK SURFACES.
- 31. THE FOLLOWING LOCATIONS SHALL EACH HAVE A DEDICATED 20AMP CIRCUIT: bathrooms, laundry room, kitchen, and garage
- 32. LUMINAIRES IN CLOSETS SHALL BE LISTED FOR SUCH USE, AND WILL FOLLOW ALL DIMENSIONAL CLEARANCES.

SD/CO NOTES

PER CBC 907.2.11, SMOKE ALARMS SHALL BE LISTED AS COMPLYING WITH UL 217 AND INSTALLED ACCORDING TO THE PROVISION OF THIS CODE AND THE HOUSEHOLD FIRE WARNING EQUIPMENT PROVISIONS OF NFPA 72.

- 1. SMOKE ALARMS SHALL BE INSTALLED A MINIMUM OF 20 FEET HORIZONTAL DISTANCE FROM A PERMANENTLY INSTALLED COOKING APPLIANCE. EXCEPTION: IONIZATION SMOKE ALARMS WITH AN ALARM SILENCING SWITCH OR PHOTOELECTRIC SMOKE ALARMS SHALL BE INSTALLED A MINIMUM OF 10 FEET FROM A PERMANENTLY INSTALLED COOKING APPLIANCE.
- 2. SMOKE ALARMS SHALL BE INSTALLED NOT LESS THAN A 3 FOOT (0.91 M)
 HORIZONTAL DISTANCE FROM THE DOOR OR OPENING OF A BATHROOM
 THAT CONTAINS A BATHTUB OR SHOWER UNLESS THIS WOULD PREVENT
 PLACEMENT OF A SMOKE ALARM REQUIRED BY OTHER SECTIONS OF THE
 CODE
- SMOKE ALARMS AND SMOKE DETECTORS SHALL NOT BE INSTALLED WITHIN A 36 IN HORIZONTAL PATH FROM THE SUPPLY REGISTERS OF A FORCED AIR HEATING OR COOLING SYSTEM AND SHALL BE INSTALLED OUTSIDE OF THE DIRECT AIRFLOW FROM THOSE REGISTERS.

WATER HEATER NOTES

PER CENC 150.0(N), THE FOLLOWING ARE REQUIRED FOR NEW WATER HEATER SYSTEM:

- 1. 120 V ELECTRICAL RECEPTACLE THAT IS WITHIN 3 FEET FROM THE WATER HEATER AND ACCESSIBLE TO THE WATER HEATER WITH NO OBSTRUCTION
- 2. A CATEGORY ILL OR IV VENT, OR A TYPE B VENT WITH STRAIGHT PIPE BETWEEN THE OUTSIDE TERMINATION AND THE SPACE WHERE THE WATER HEATER IS INSTALLED
- 3. A CONDENSATE DRAIN THAT IS NO MORE THAN 2 INCHES HIGHER THAN THE BASE OF THE INSTALLED WATER HEATER, AND ALLOWS NATURAL DRAINING WITH PUMP ASSISTANCE
- 4. A GAS SUPPLY LINE WITH A CAPACITY OF AT LEAST 200,000 BTU/HOUR (IF REQUIRED).

BATH NOTES

- 1. SHOWERS AND SHOWER TUB/COMBINATIONS SHALL BE PROVIDED WITH INDIVIDUAL CONTROL VALVES OF THE THERMOSTATIC MIXING OR PRESSURE BALANCE TYPE.
- 2. GLAZING FOR SHOWER DOORS & ENCLOSURES SHALL BE FULLY TEMPERED & PASS THE TEST REQ. OF ANSI Z9.1, MIN. 22" WIDE DOOR, TYP.
- 3. SHOWER COMPARTMENTS AND WALLS ABOVE BATHTUBS WITH INSTALLED SHOWER HEADS SHALL BE FINISHED WITH A SMOOTH, NONABSORBENT SURFACE TO A HEIGHT NOT
- 4. WATER RESISTANT GYPSUM BOARD SHALL NOT BE USED WHERE THERE WILL BE DIRECT EXPOSURE TO WATER, OR IN AREAS OF HIGH HUMIDITY, PER CRC R702.3.8.1. USE CEMENTITIOUS BACKER BOARD AT SHOWER AND BATH AREAS, TYP.
- 5. FLOW RATES (PER CGBSC Section 4.303):
- ALL TOILETS SHALL BE MAX 1.28 GPF
 ALL LAVATORY FAUCETS SHALL BE MAX 1.2 GPM @ 60 PSI

LESS THAN 72 INCHES ABOVE DRAIN INLET, TYP.

ALL SHOWER HEADS SHALL BE MAX 1.8 GPM @ 80 PSI
 ALL KITCHEN / UTIL FAUCETS SHALL BE MAX 1.8 GPM @ 60 PSI

6. EXHAUST FAN; MIN 50 CFM, ENERGY STAR W/ HUMIDITY CONTROL

- GENERAL NOTES
- KNR Design Studio is referred to as the "Designer".
 All work is to be performed in accordance with all governing codes, ordinances, and regulations.
- 3. General Contractor shall coordinate with applicable utility companies when rerouting electrical, telephone, cable TV, gas, water, sanitary sewer services, or any other utility.
- General Contractor shall be responsible for coordination and execution of the work shown or implied

in the construction documents and is responsible for construction means, methods, and procedures.

- General Contractor shall coordinate all facets of his work and all trades involved to avoid conflict in the location, installation, and construction of all items of work as indicated on the construction documents. If any work is to be installed by the Owner directly, allowances for the Owner's work must be made. Coordinate with Designer.
- 6. General Contractor shall leave the job site "broom clean" at the end of each working day. All materials shall be stored in a neat and safe place to avoid accidents.
- 7. In case of any discrepancy in the contract documents, consult the Designer before proceeding.
- 8. No dimensions shall be taken by scaling from the drawings. Details take precedence over general sections or floor plans. If dimensions must be clarified, consult the Designer. Refer to the Cover Sheet for dimensioning standards.
- 9. Verify all dimensions on the job site prior to ordering or manufacturing.
- 10. General Contractor shall review all architectural drawings including finish plans, electrical plans, and mechanical plans before framing. Coordinate recessed light fixture locations, shafts, and HVAC ductwork prior to framing. It is imperative that framing member locations do not conflict with locations of recessed light fixtures.
- 11. General Contractor shall install all appliances specified and all new equipment according to manufacturer's instructions. All guarantees, instruction booklets, and information regarding new equipment shall be handed directly to the Owner in one manila envelope at the time of substantial completion. Contractor shall verify that every piece of equipment and every appliance is in perfect working order and that information about all warranties and guarantees is made known to the Owner.
- 12. The installer of each major unit of work is required to inspect the substrate and conditions to receive work and shall report all unsatisfactory conditions to the General Contractor and not proceed until satisfactory conditions are attained.
- 13. For mounting heights not clearly outlined in the plans or schedules, coordinate with the Designer. Designer shall confirm all electrical device and light fixture locations before Contractor pulls wire.
- 14. Provide solid blocking as necessary for wall mounted shelves, fixtures, fittings, and accessories even when work is to be done by Owner directly. Coordinate work and locations with Owner / Designer.
- 15. All fastening devices to be concealed, unless otherwise shown.16. Weatherstrip all exterior doors and windows.
- 17. Caulk or otherwise seal around all openings to limit infiltration, including but not limited to: Exterior joints around windows and door frames, between sole plates and floors and between exterior wall
- 18. General Contractor shall verify that all work on the exterior of the project is watertight. All joints exposed to the elements shall be tested for water tightness prior to substantial completion.
- All construction sites must comply with applicable provisions of the CFC Chapter 14 and Standard Detail and Specification SI-17.
- 20. An automatic sprinkler system shall be provided. all fire sprinkler plans shall be submitted directly by a licensed c-16 fire sprinkler contractor to Santa Clara County Fire Department. California water service requires double check valves installed on buildings equipped with
- 21. Potable water supplies shall be protected from contamination caused by fire protection water supplies.
- 22. Approved numbers or addresses shall be placed on all new and existing-to-remain buildings in such a position as to be plainly visible and legible from the street or road fronting the property. Numbers shall contrast with their background. CFC Sec. 505 w/ a minimum height of 6 inches.
- 23. Minimum 65% of construction waste to be recycled or salvaged per 2016 CALGreen 4 408 1

KNR DESIGN STUDIO

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> 681 DRISCOLL CT. PALO ALTO, CA 94306

Monsalve RESIDENCE

466 Raquel St. Los Altos, CA 94024

Single-Story Remodel / Addition

Project MONSALVE RESIDENCE


Date 16.AUG.2021


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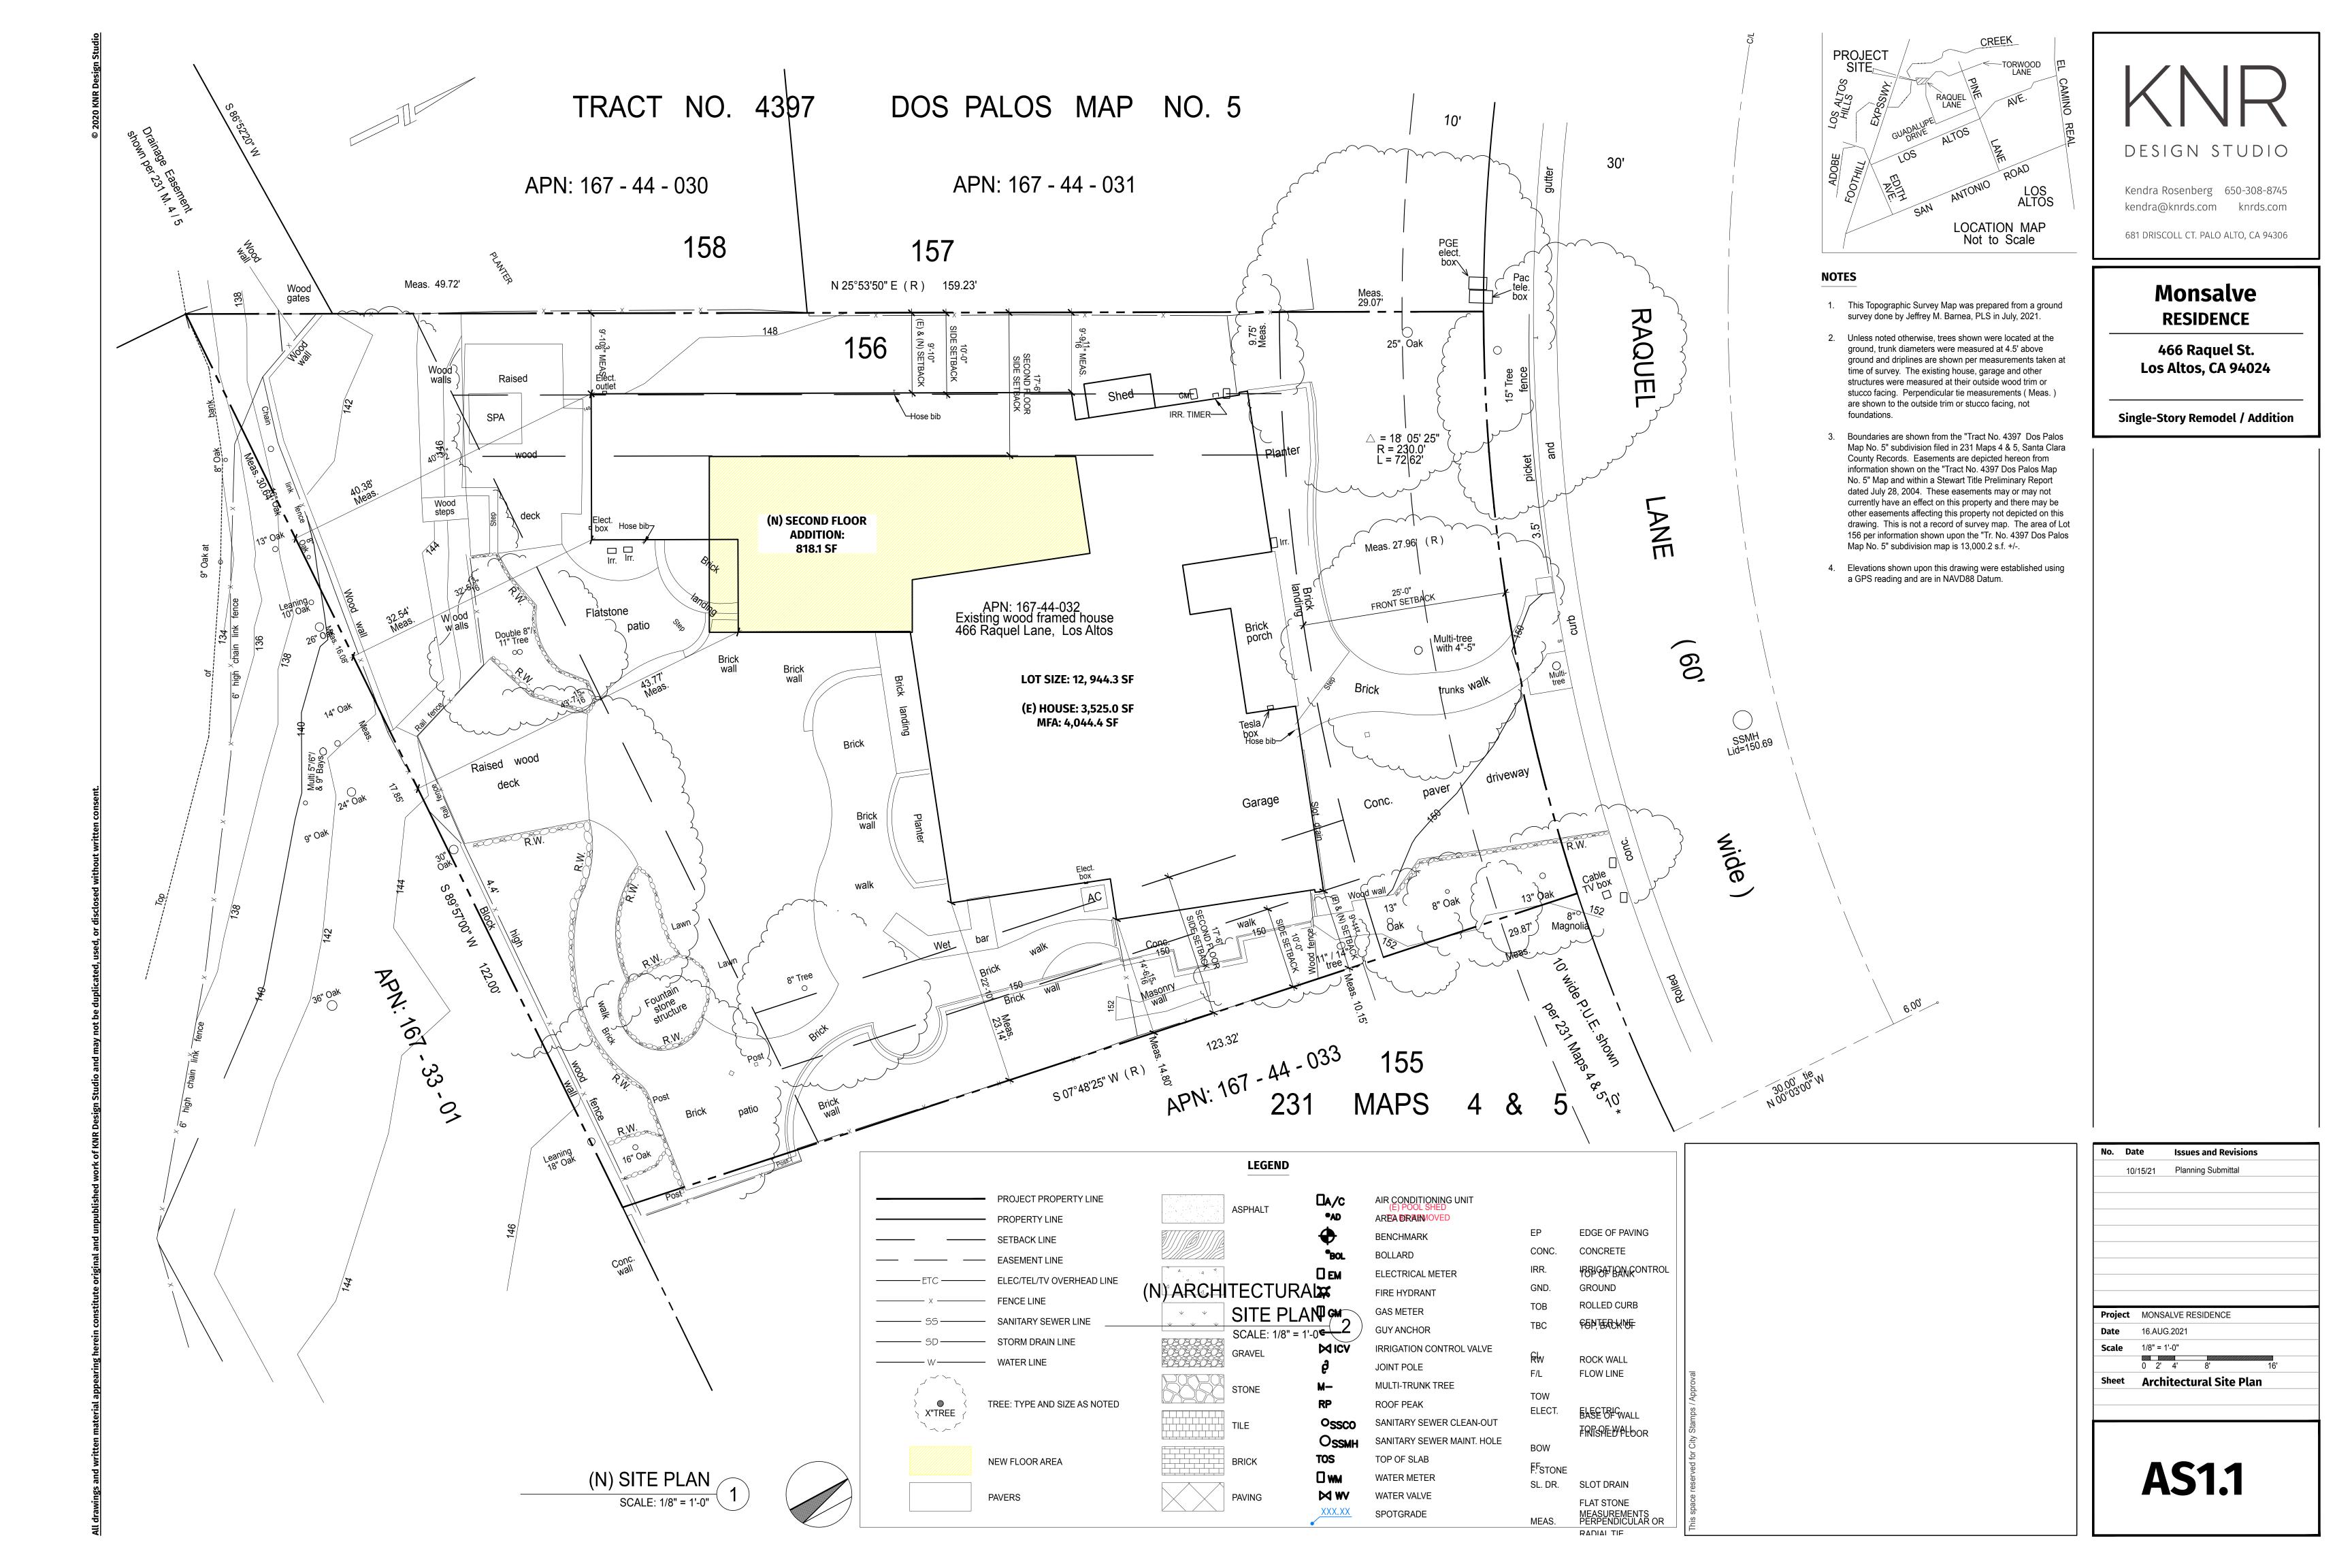
Issues and Revisions


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Sheet **Notes**





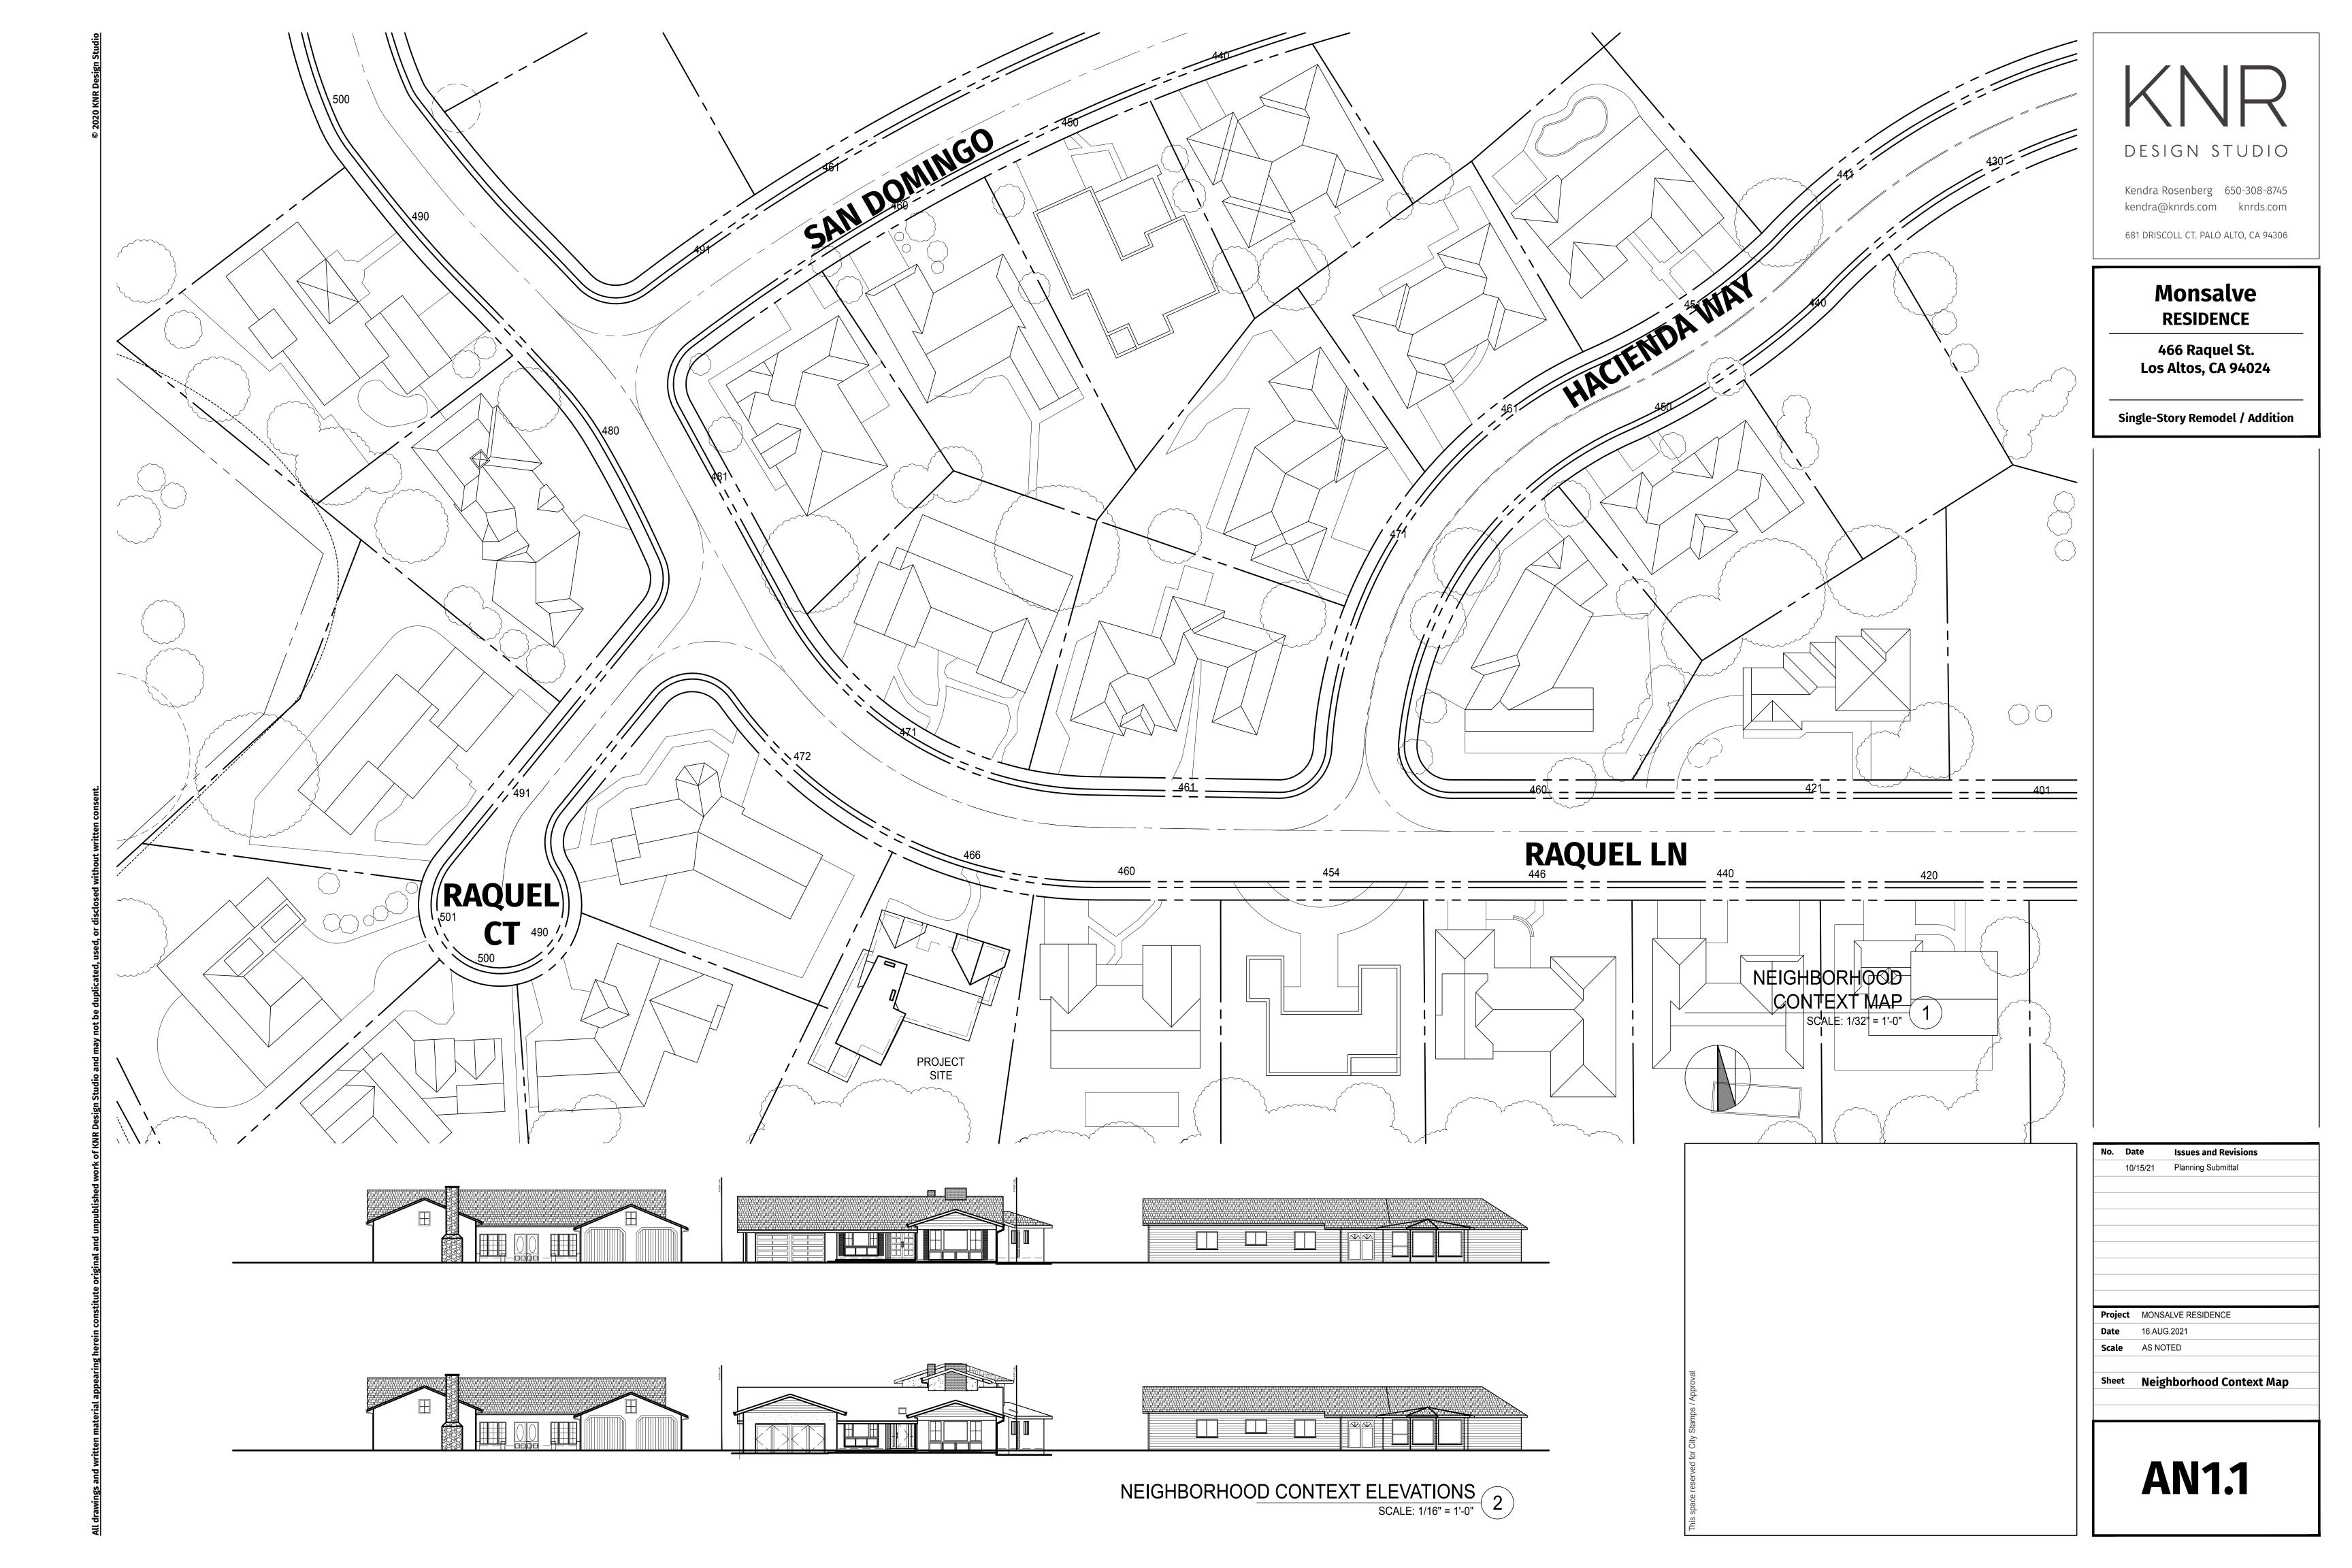

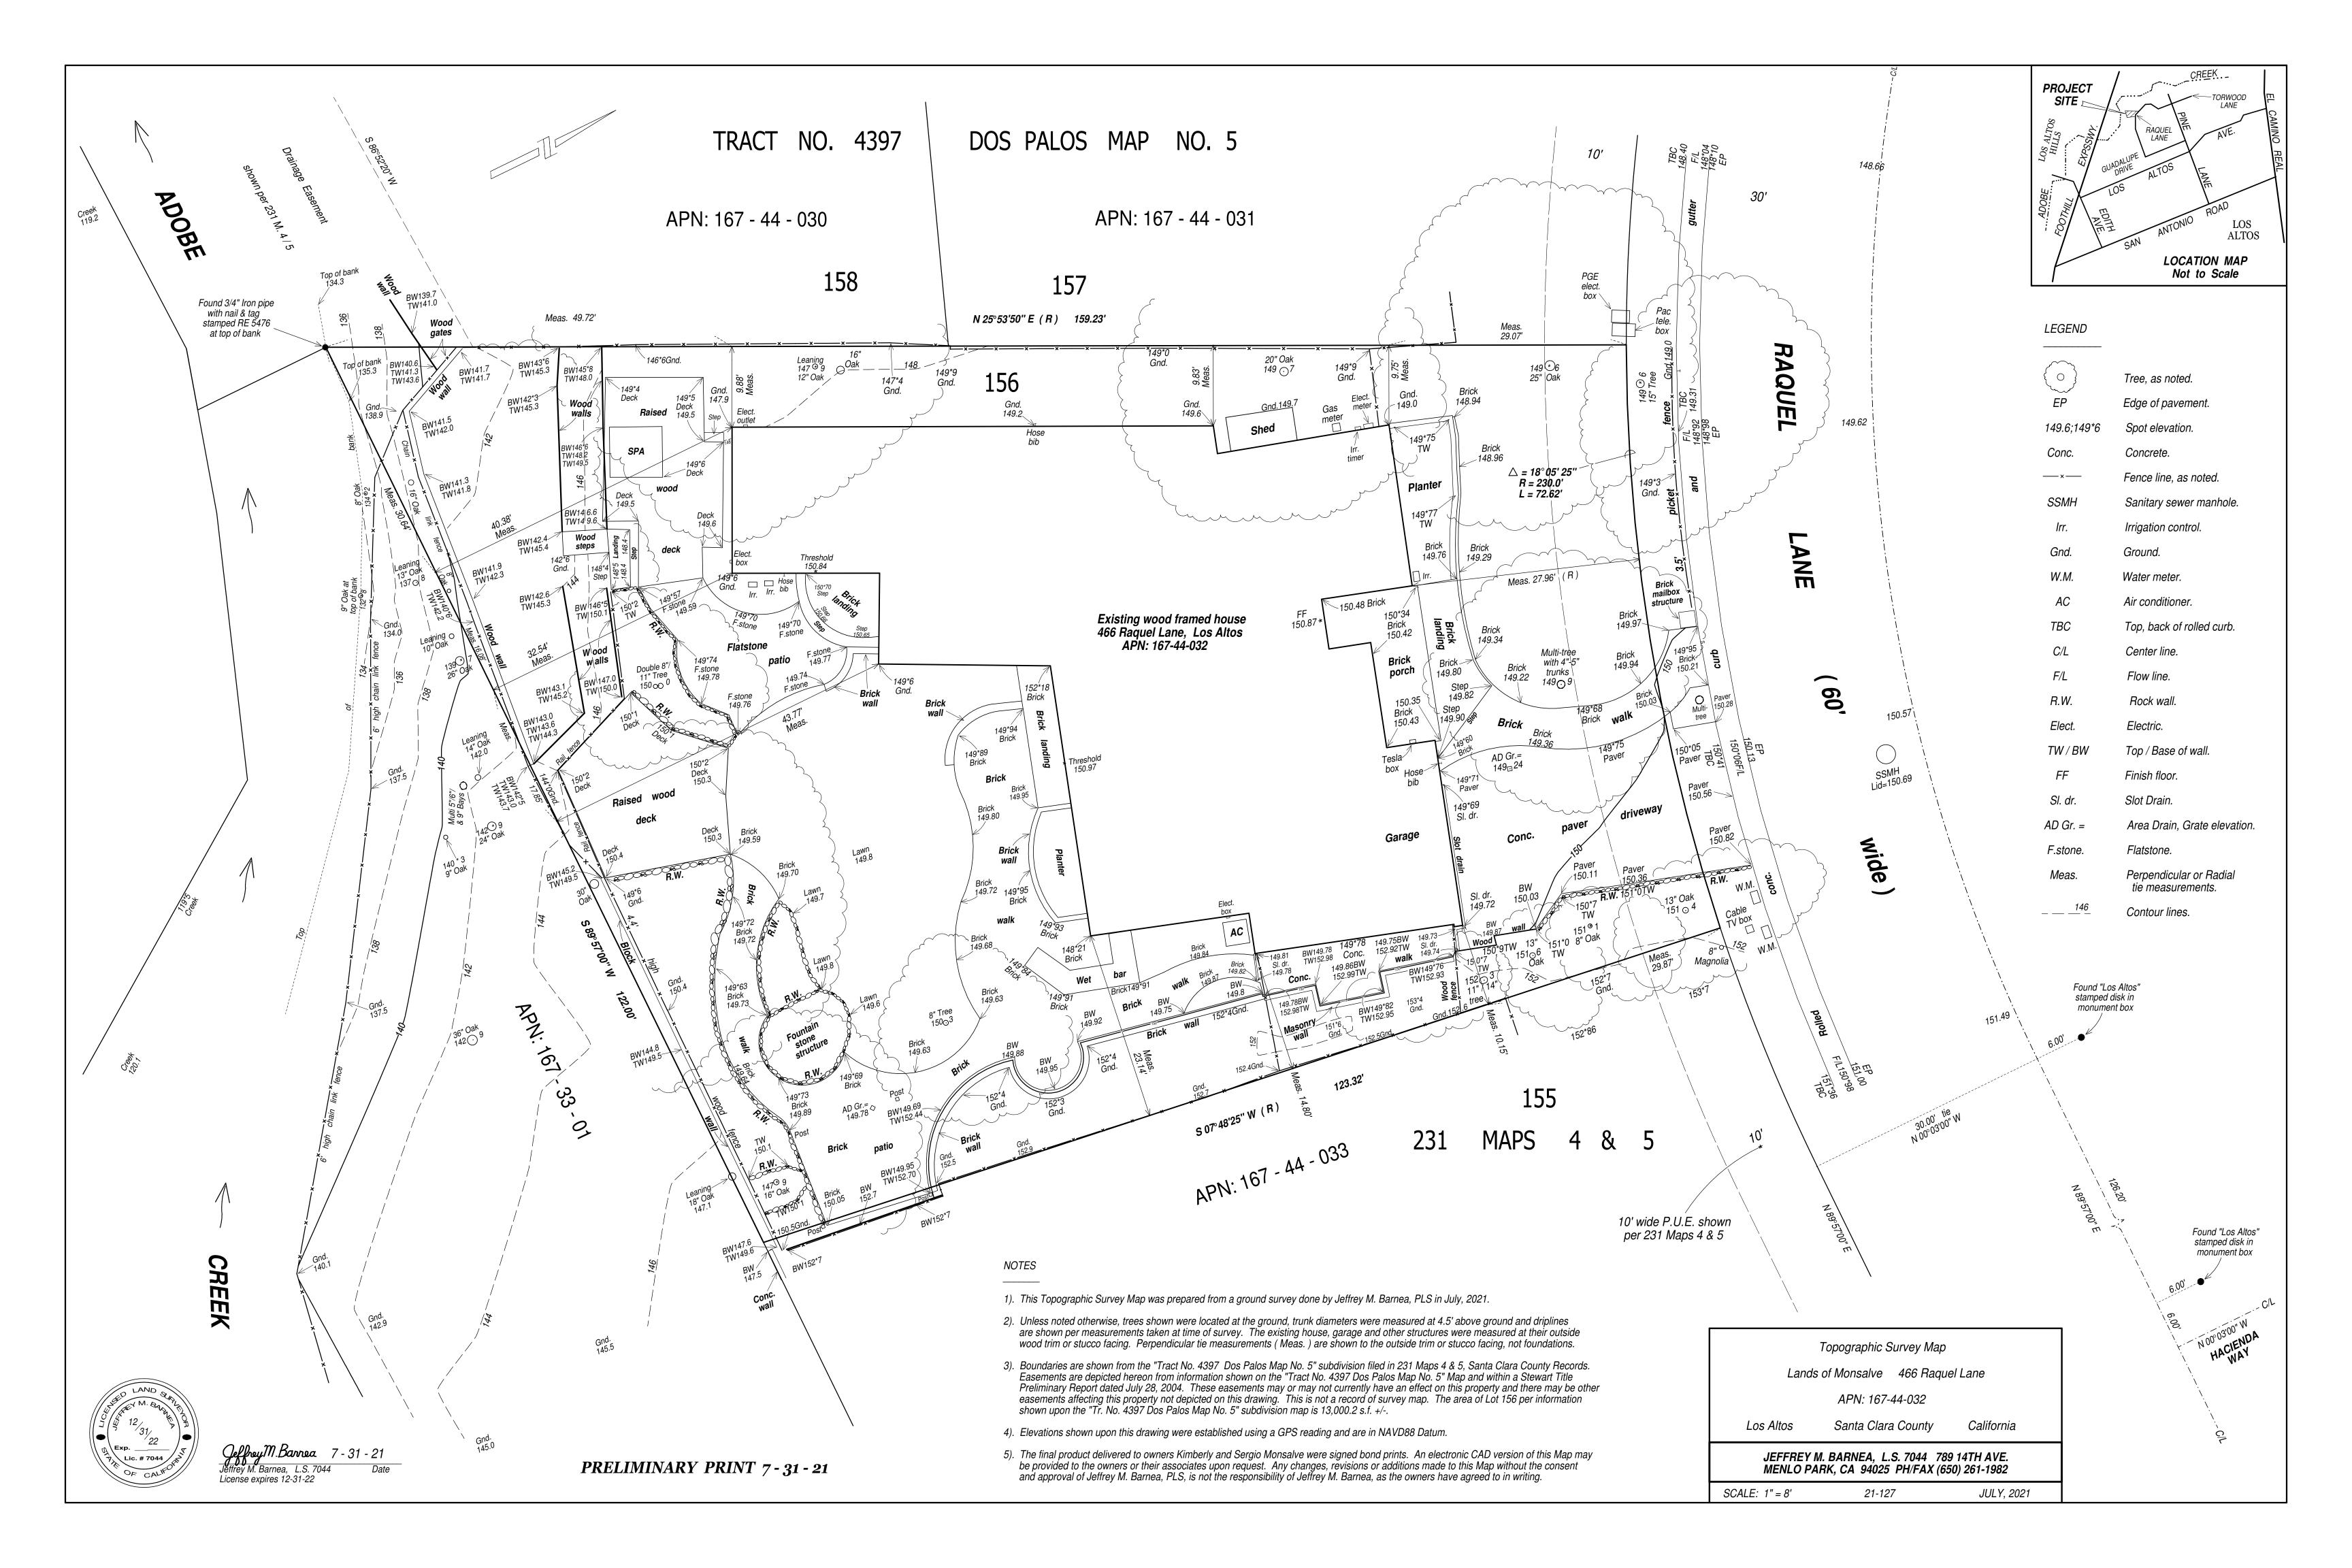

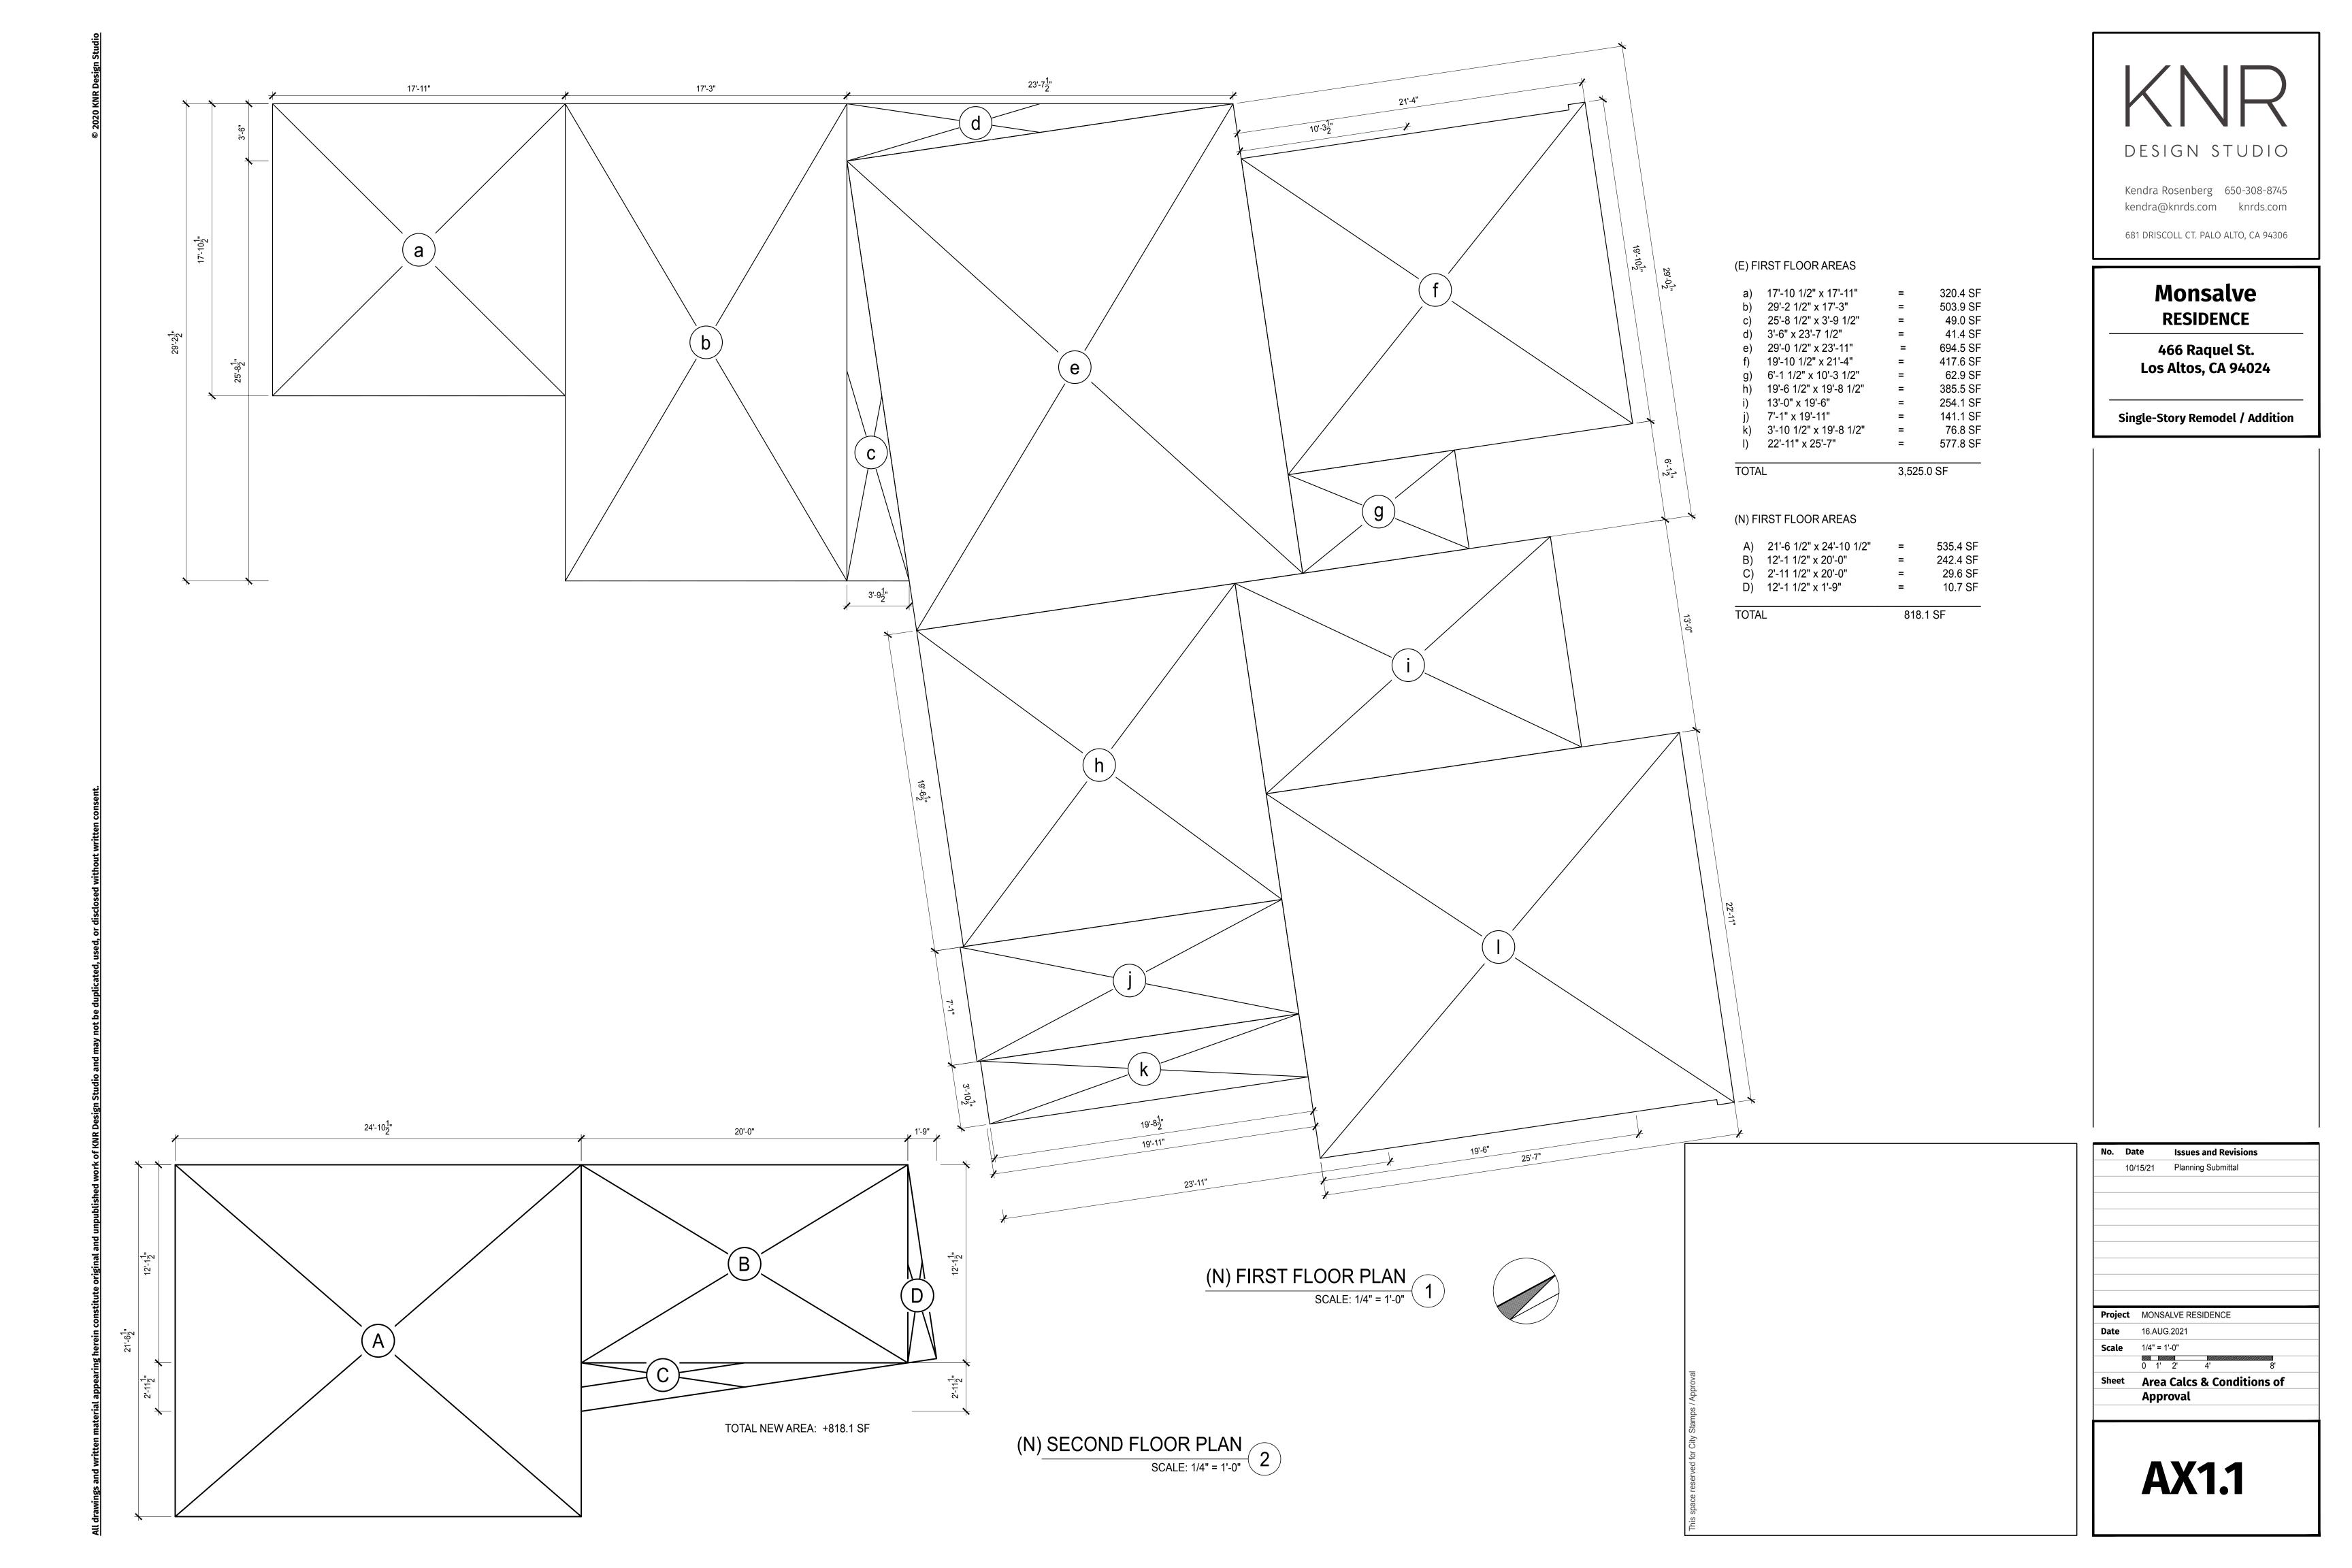DESIGN STUDIO

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Monsalve RESIDENCE

466 Raquel St. Los Altos, CA 94024

Single-Story Remodel / Addition

Date Issues and Revisions
10/15/21 Planning Submittal

Project MONSALVE RESIDENCE


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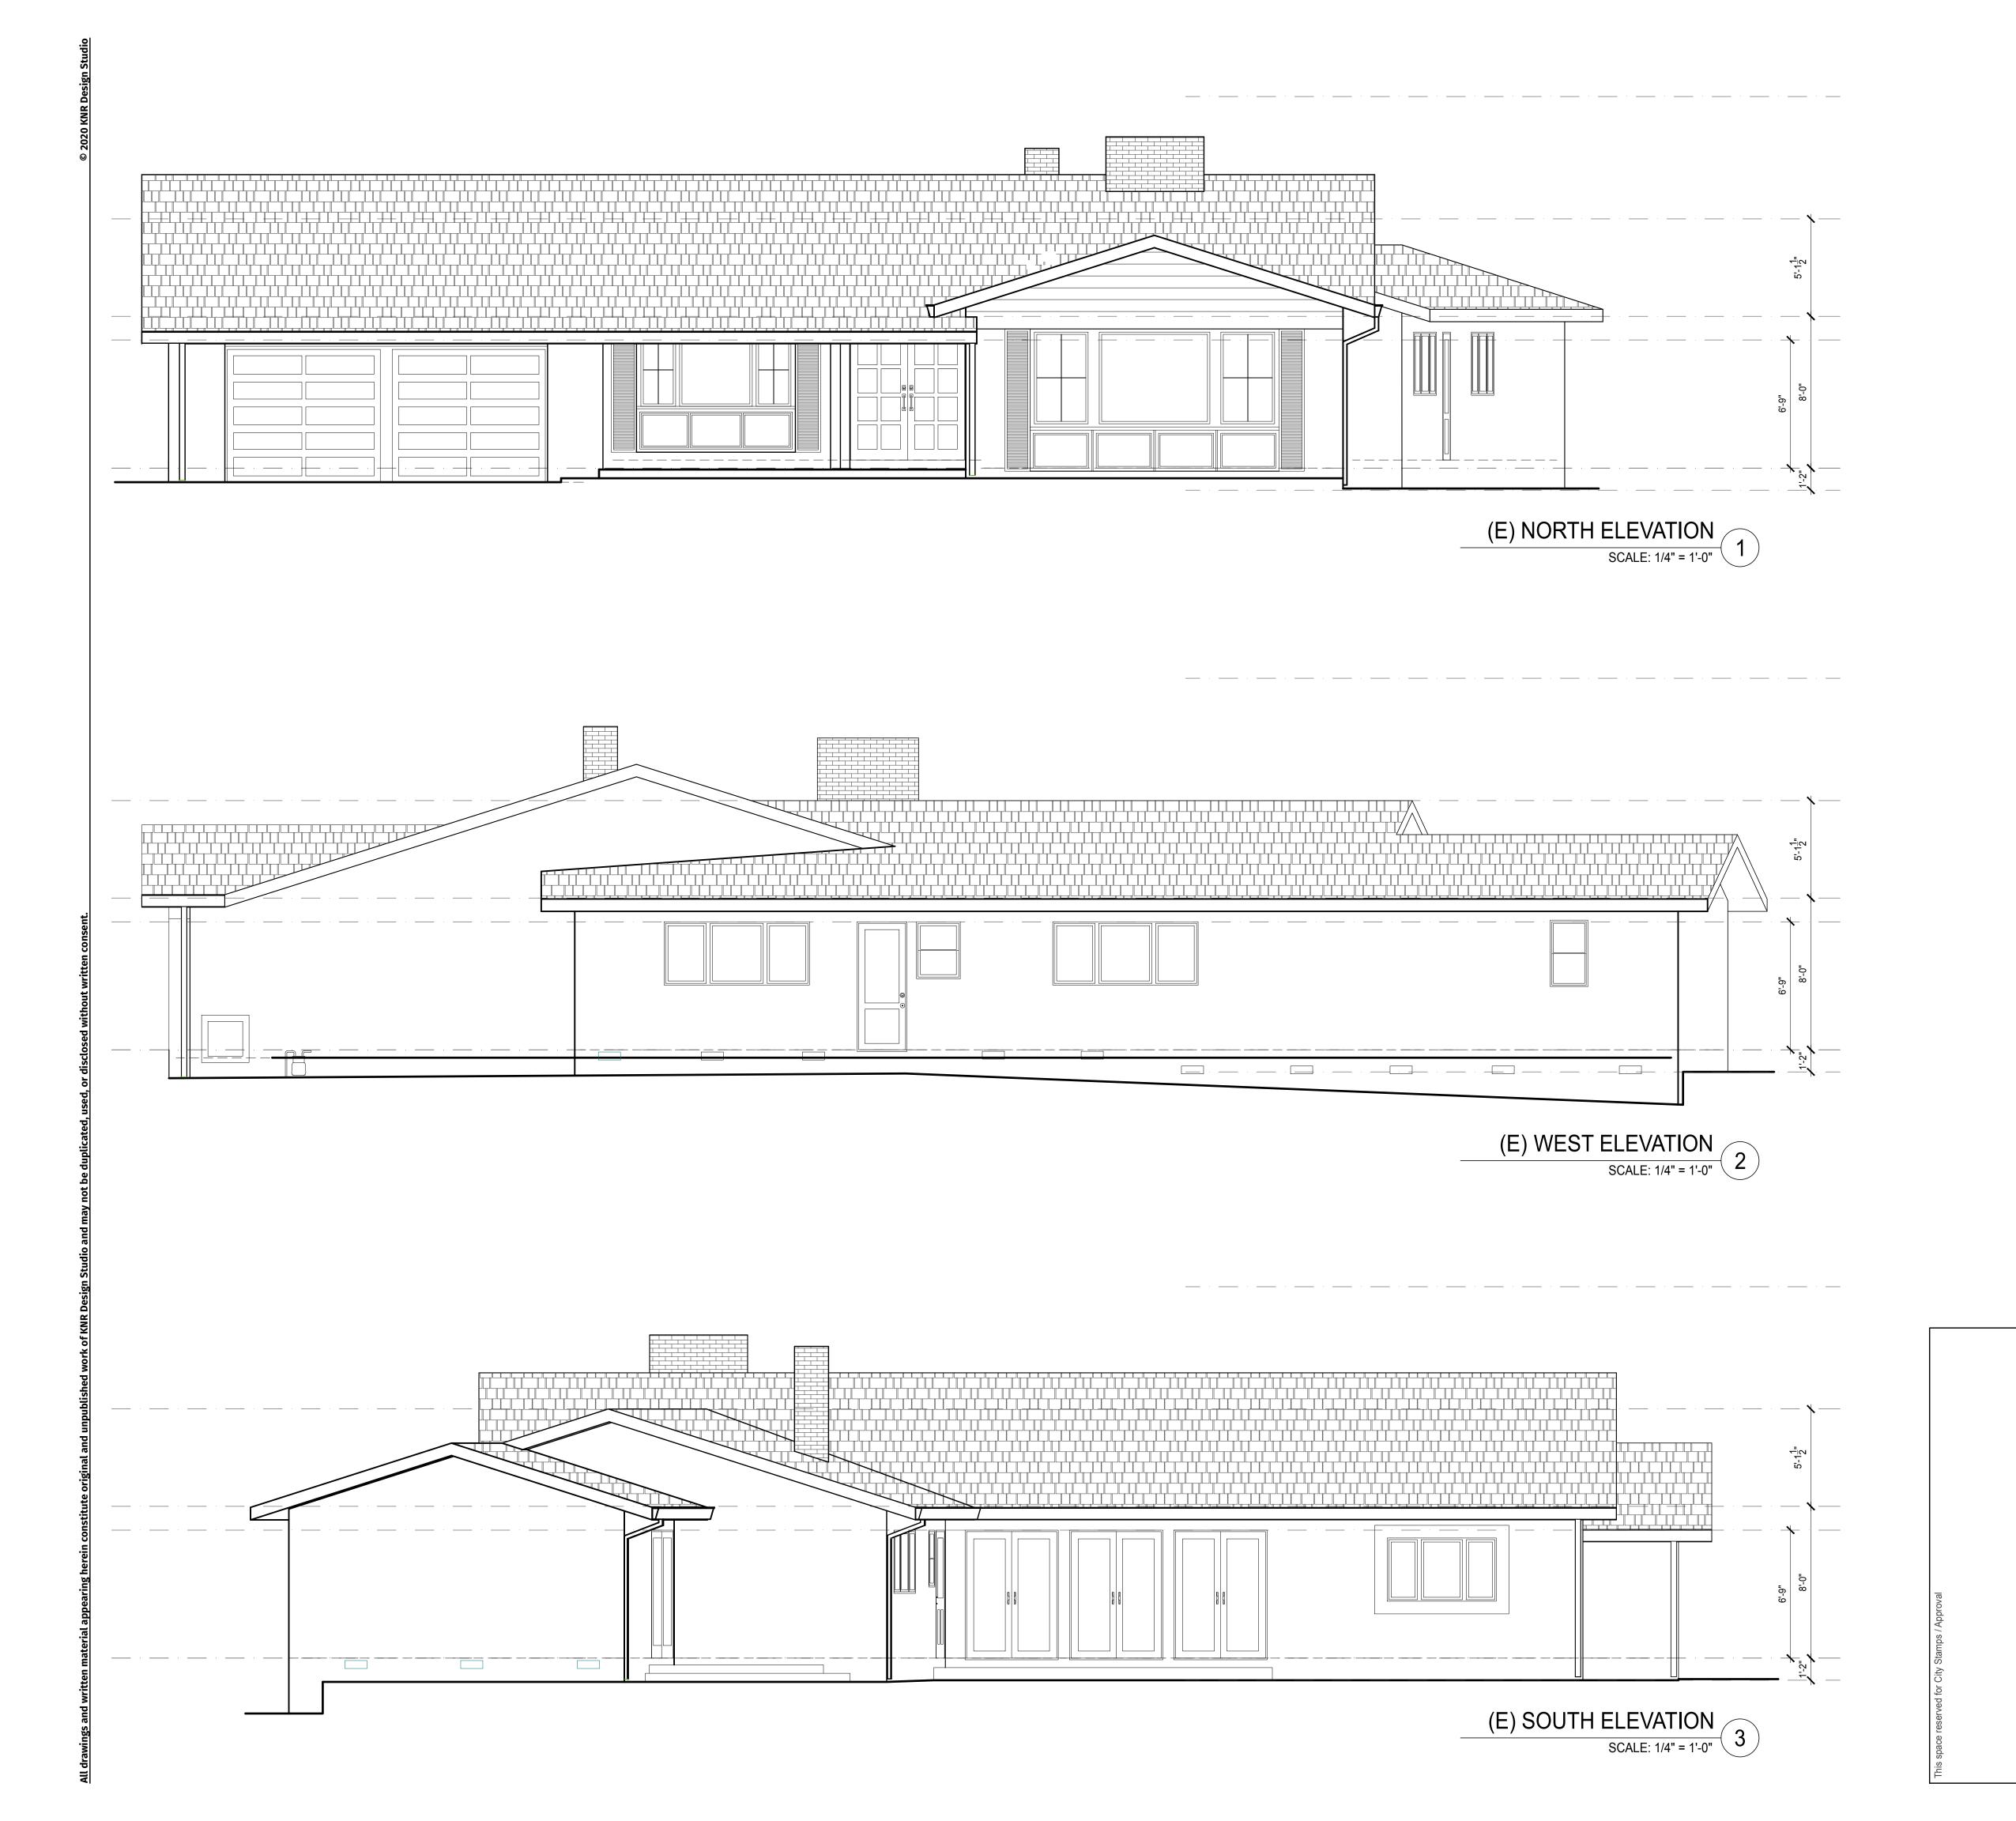
 Scale
 1/4" = 1'-0"

Sheet Demolition Floor Plan

11

DEMO FLOOR PLAN
SCALE: 1/4" = 1'-0"



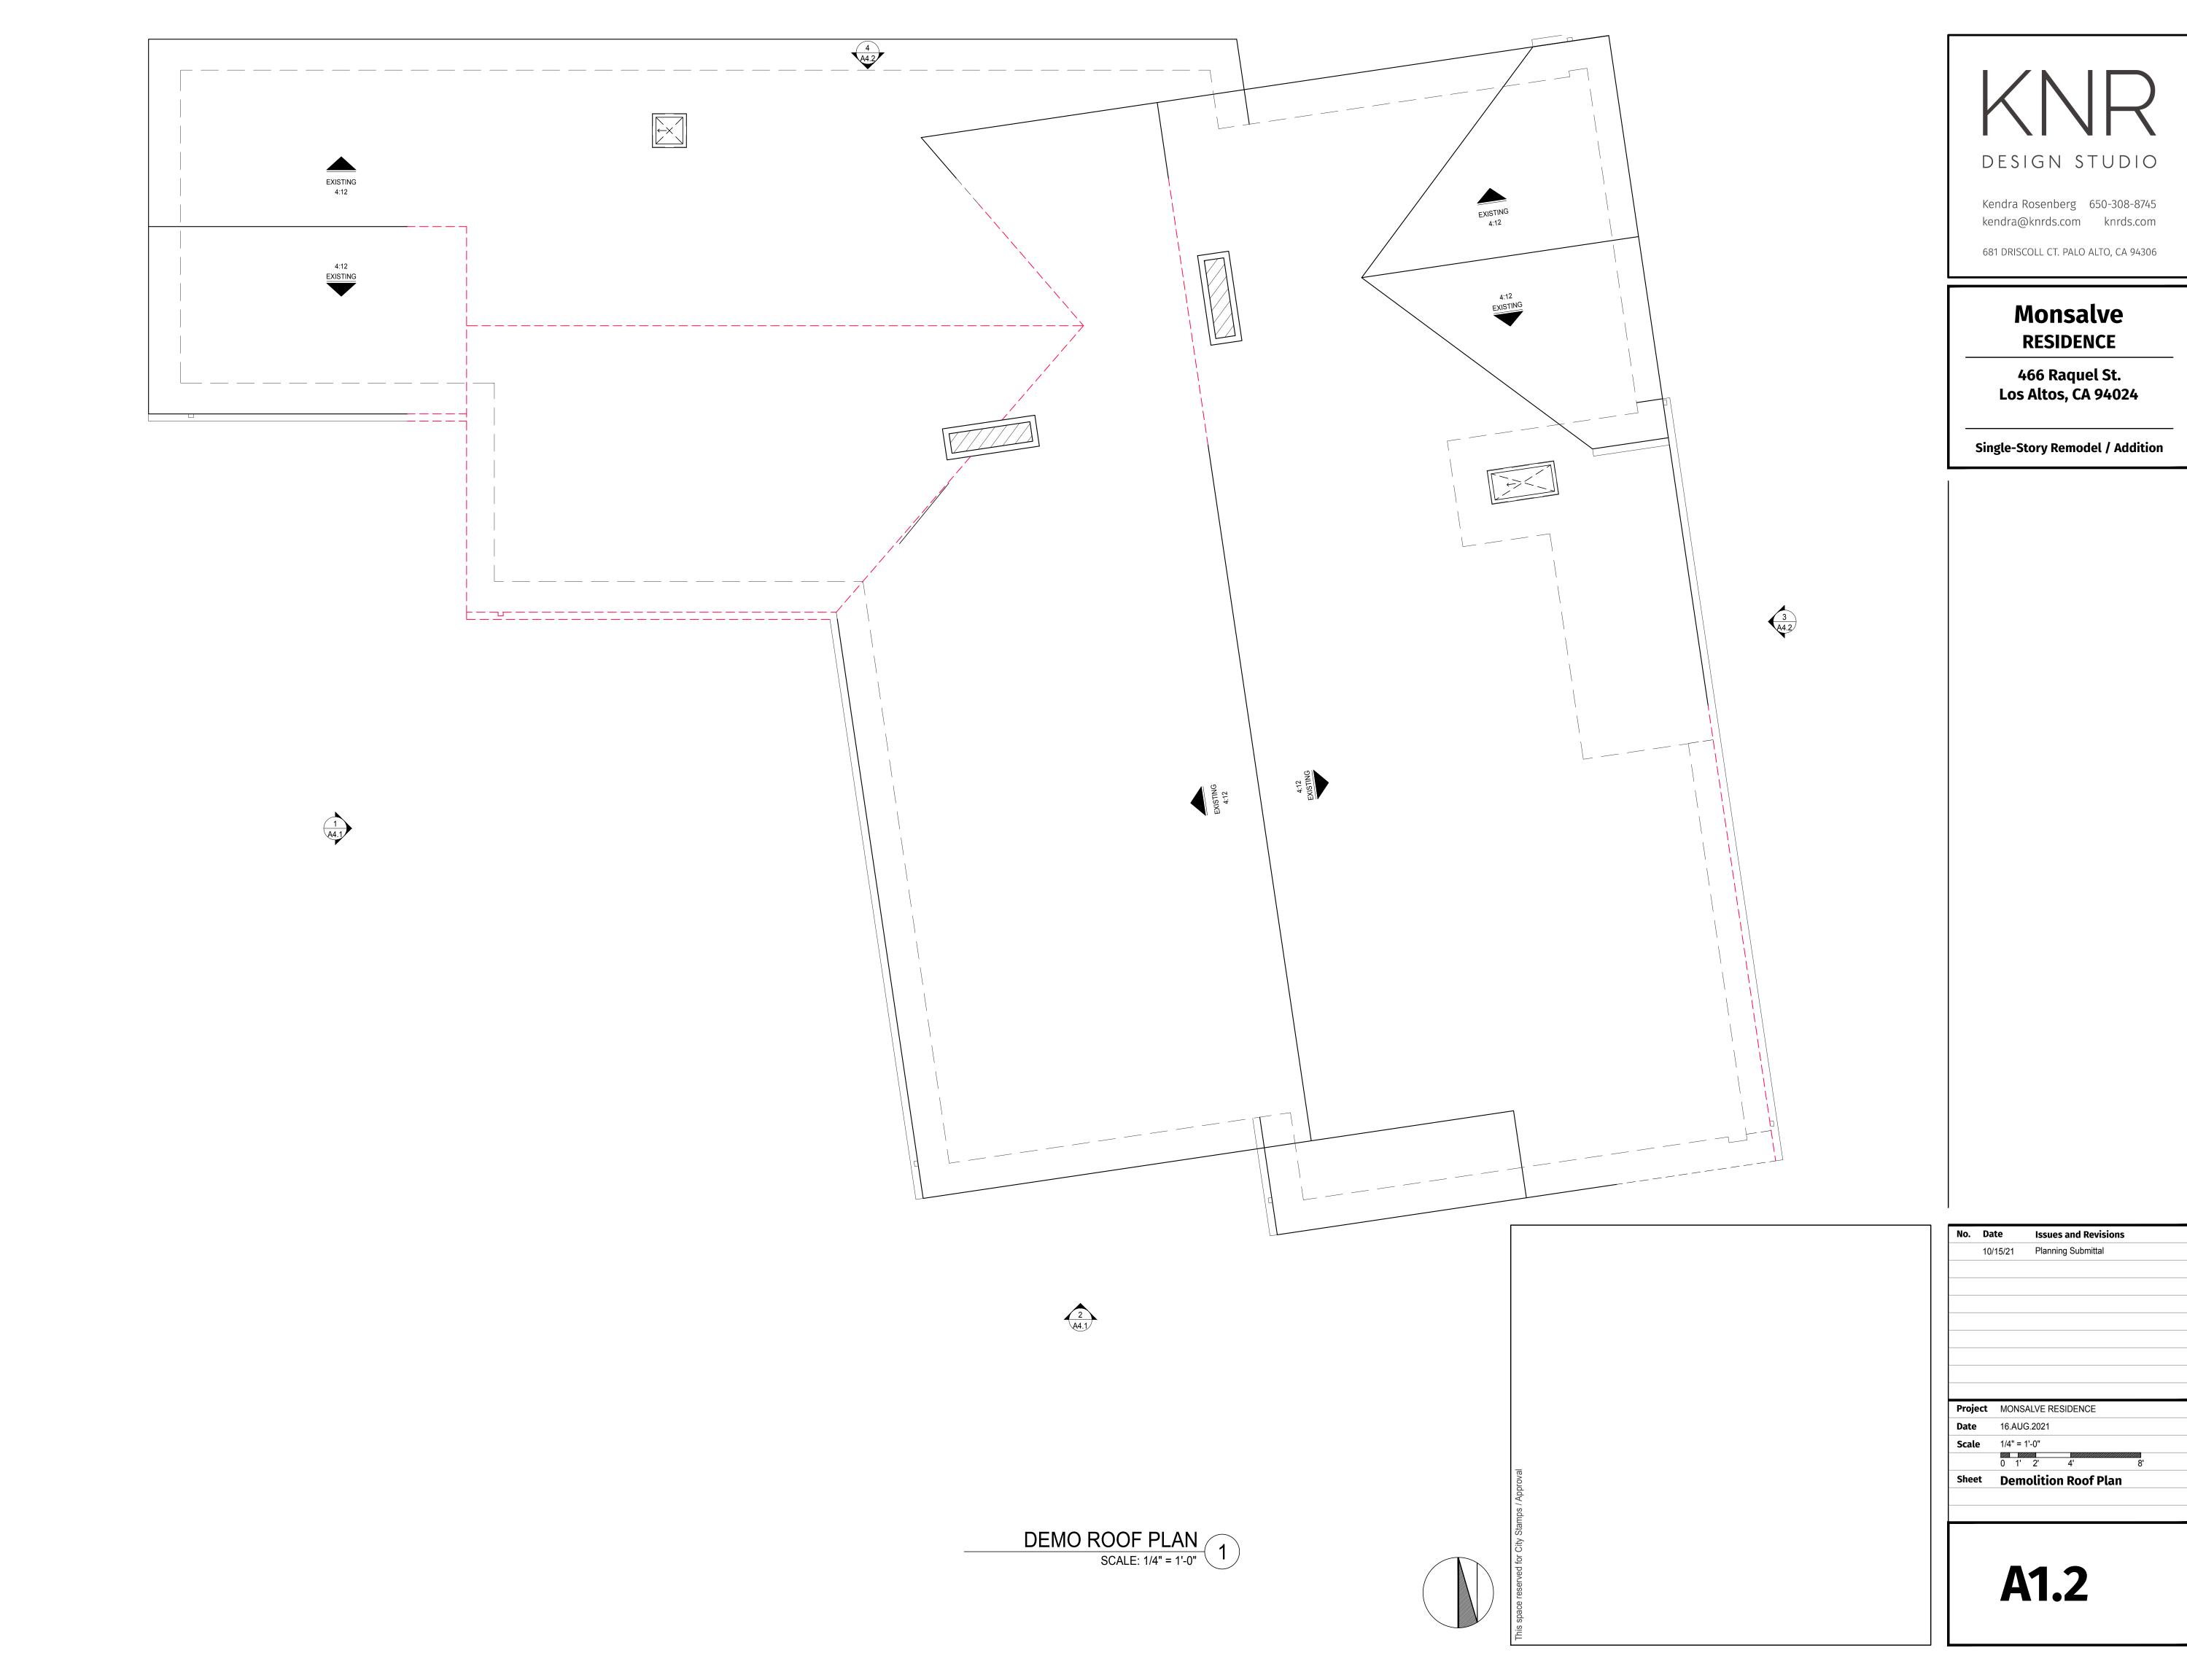




Kendra Rosenberg 650-308-8745 kendra@knrds.com knrds.com


681 DRISCOLL CT. PALO ALTO, CA 94306

Monsalve **RESIDENCE**

466 Raquel St. Los Altos, CA 94024

Single-Story Remodel / Addition

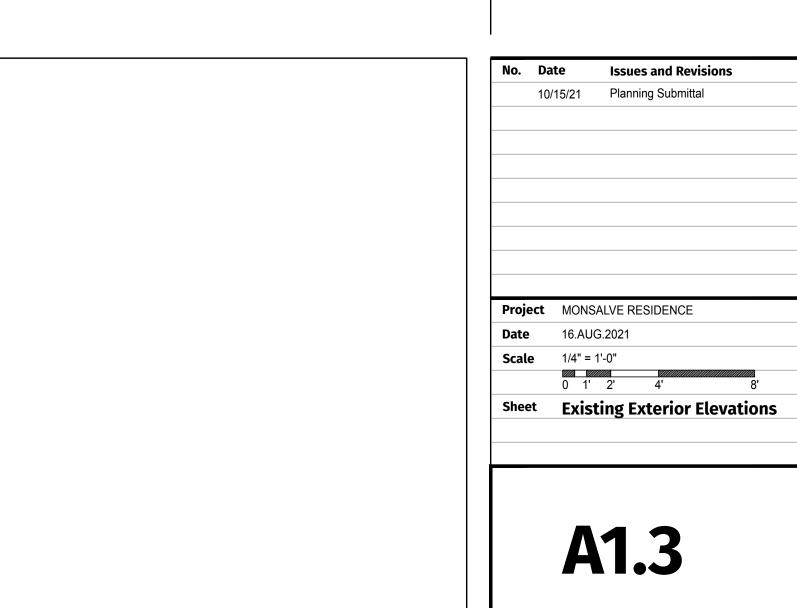

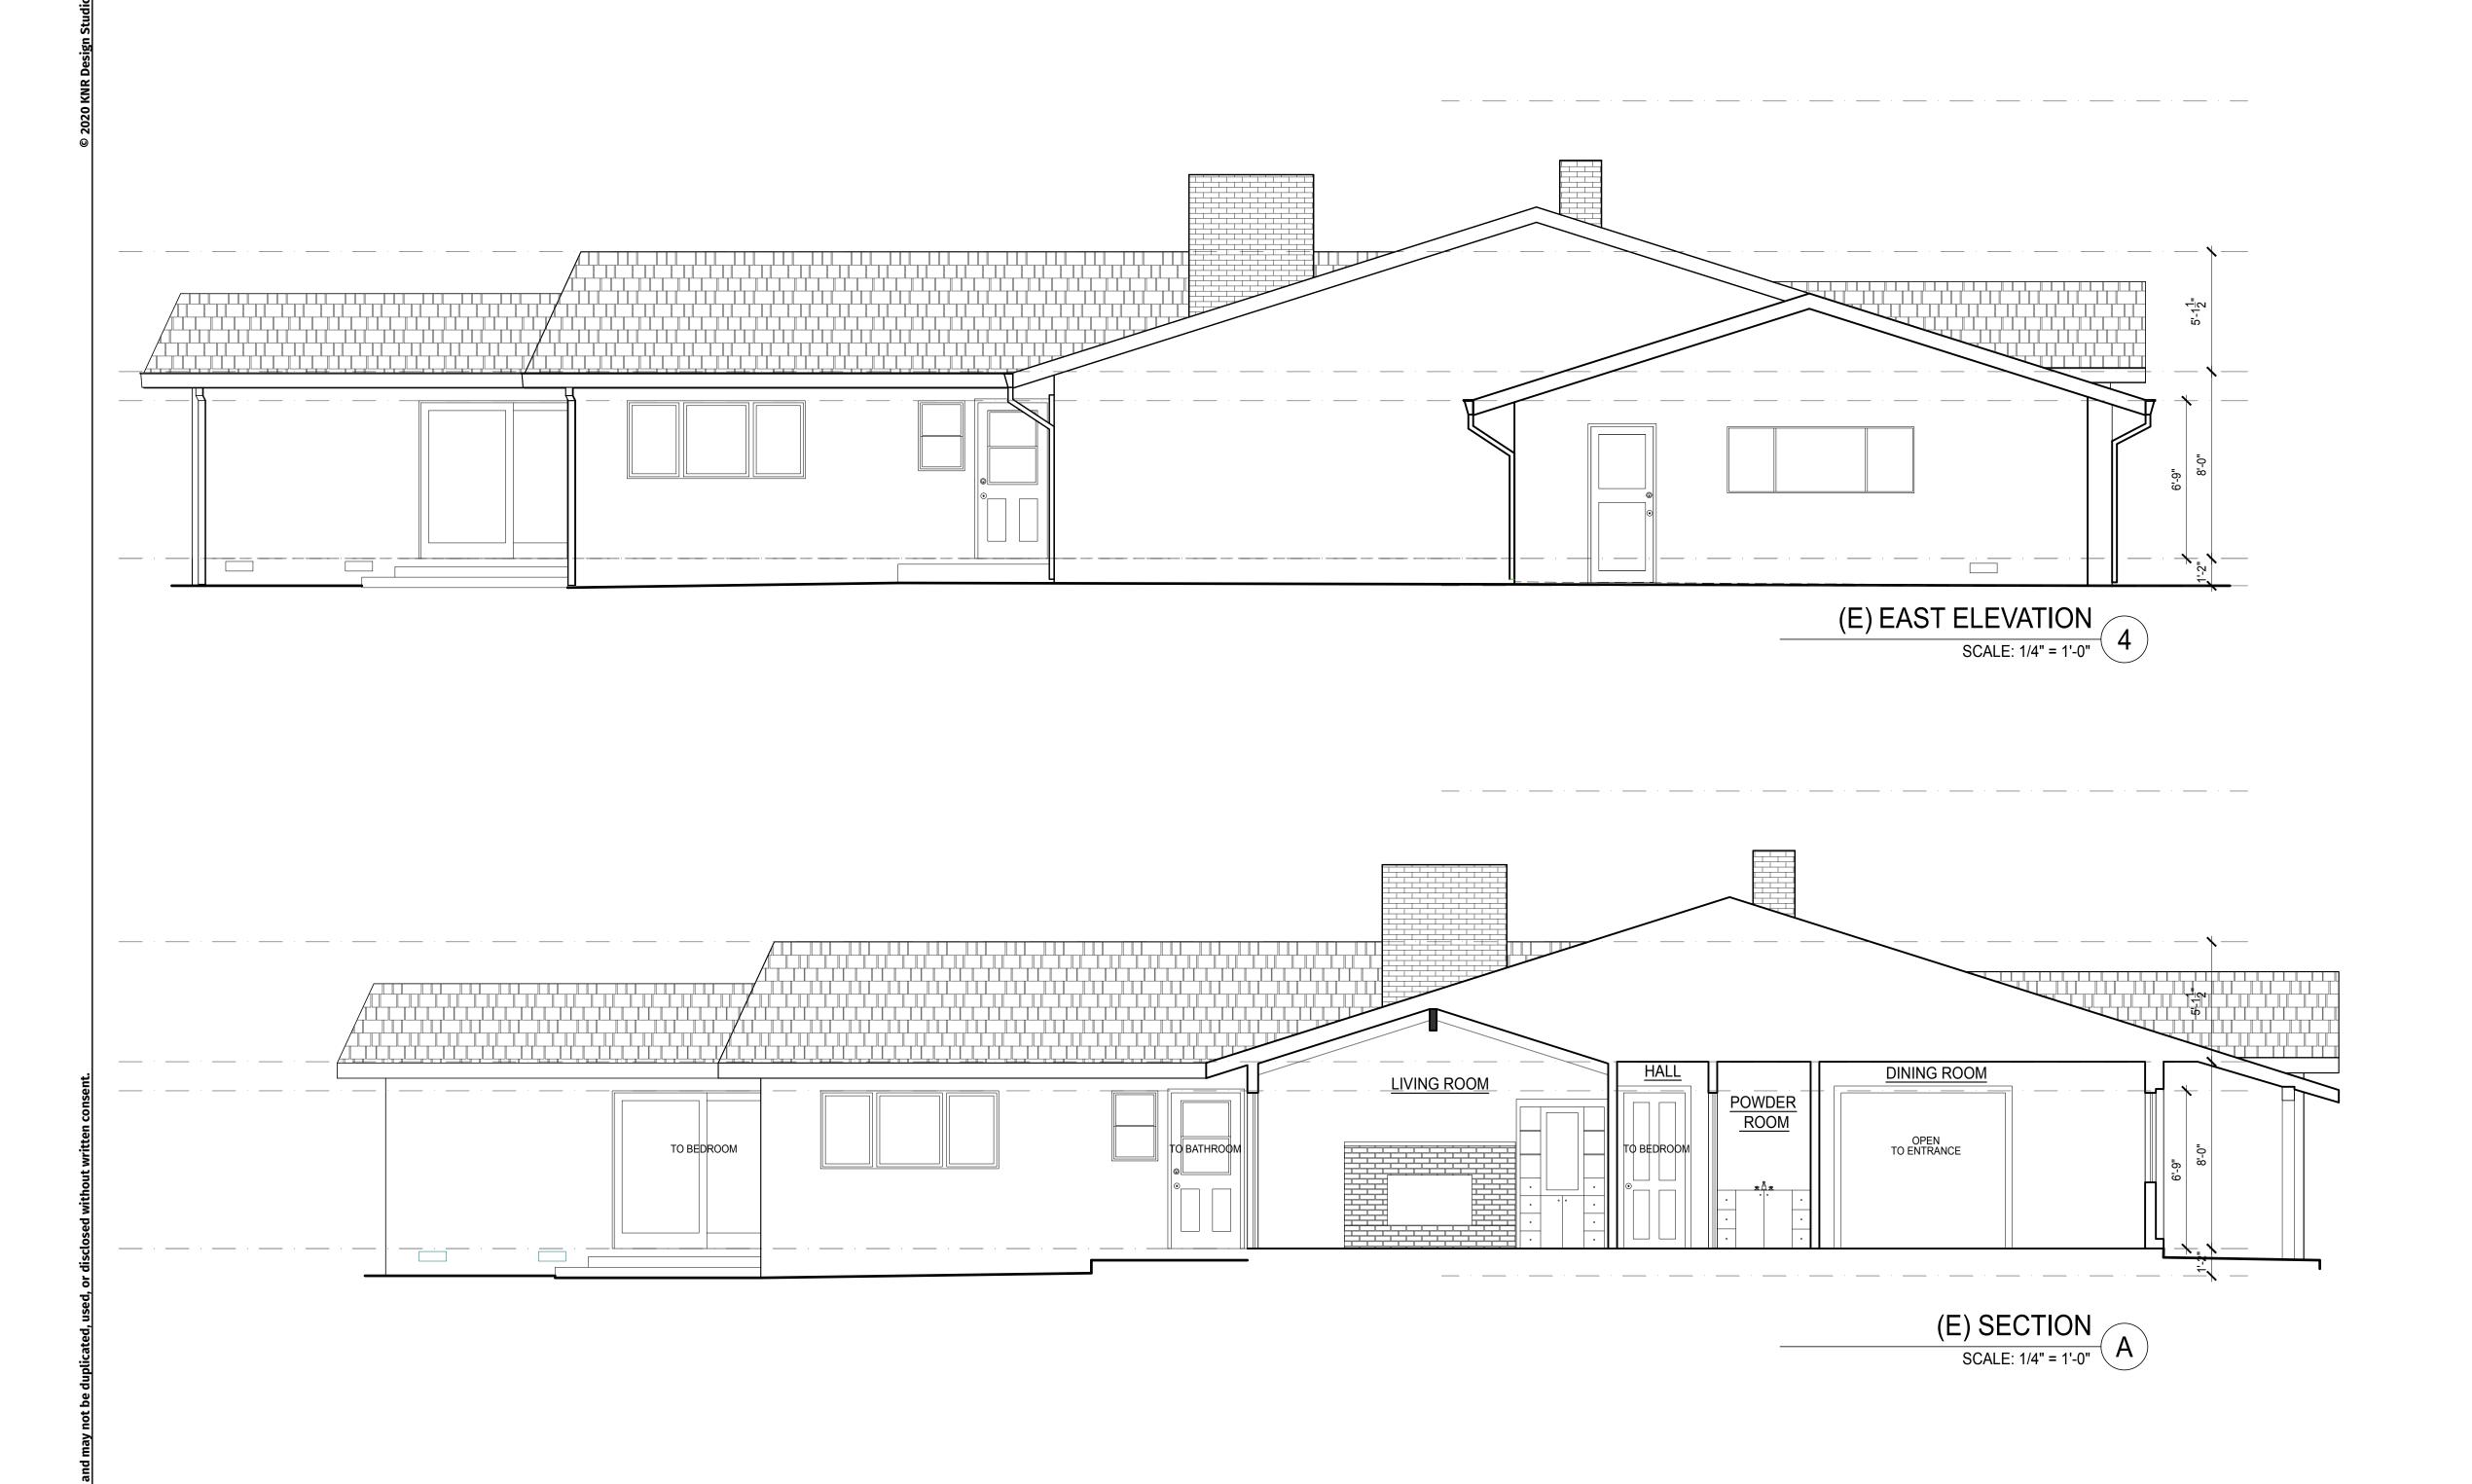



DESIGN STODI


Kendra Rosenberg 650-308-8745 kendra@knrds.com knrds.com


681 DRISCOLL CT. PALO ALTO, CA 94306


Monsalve RESIDENCE


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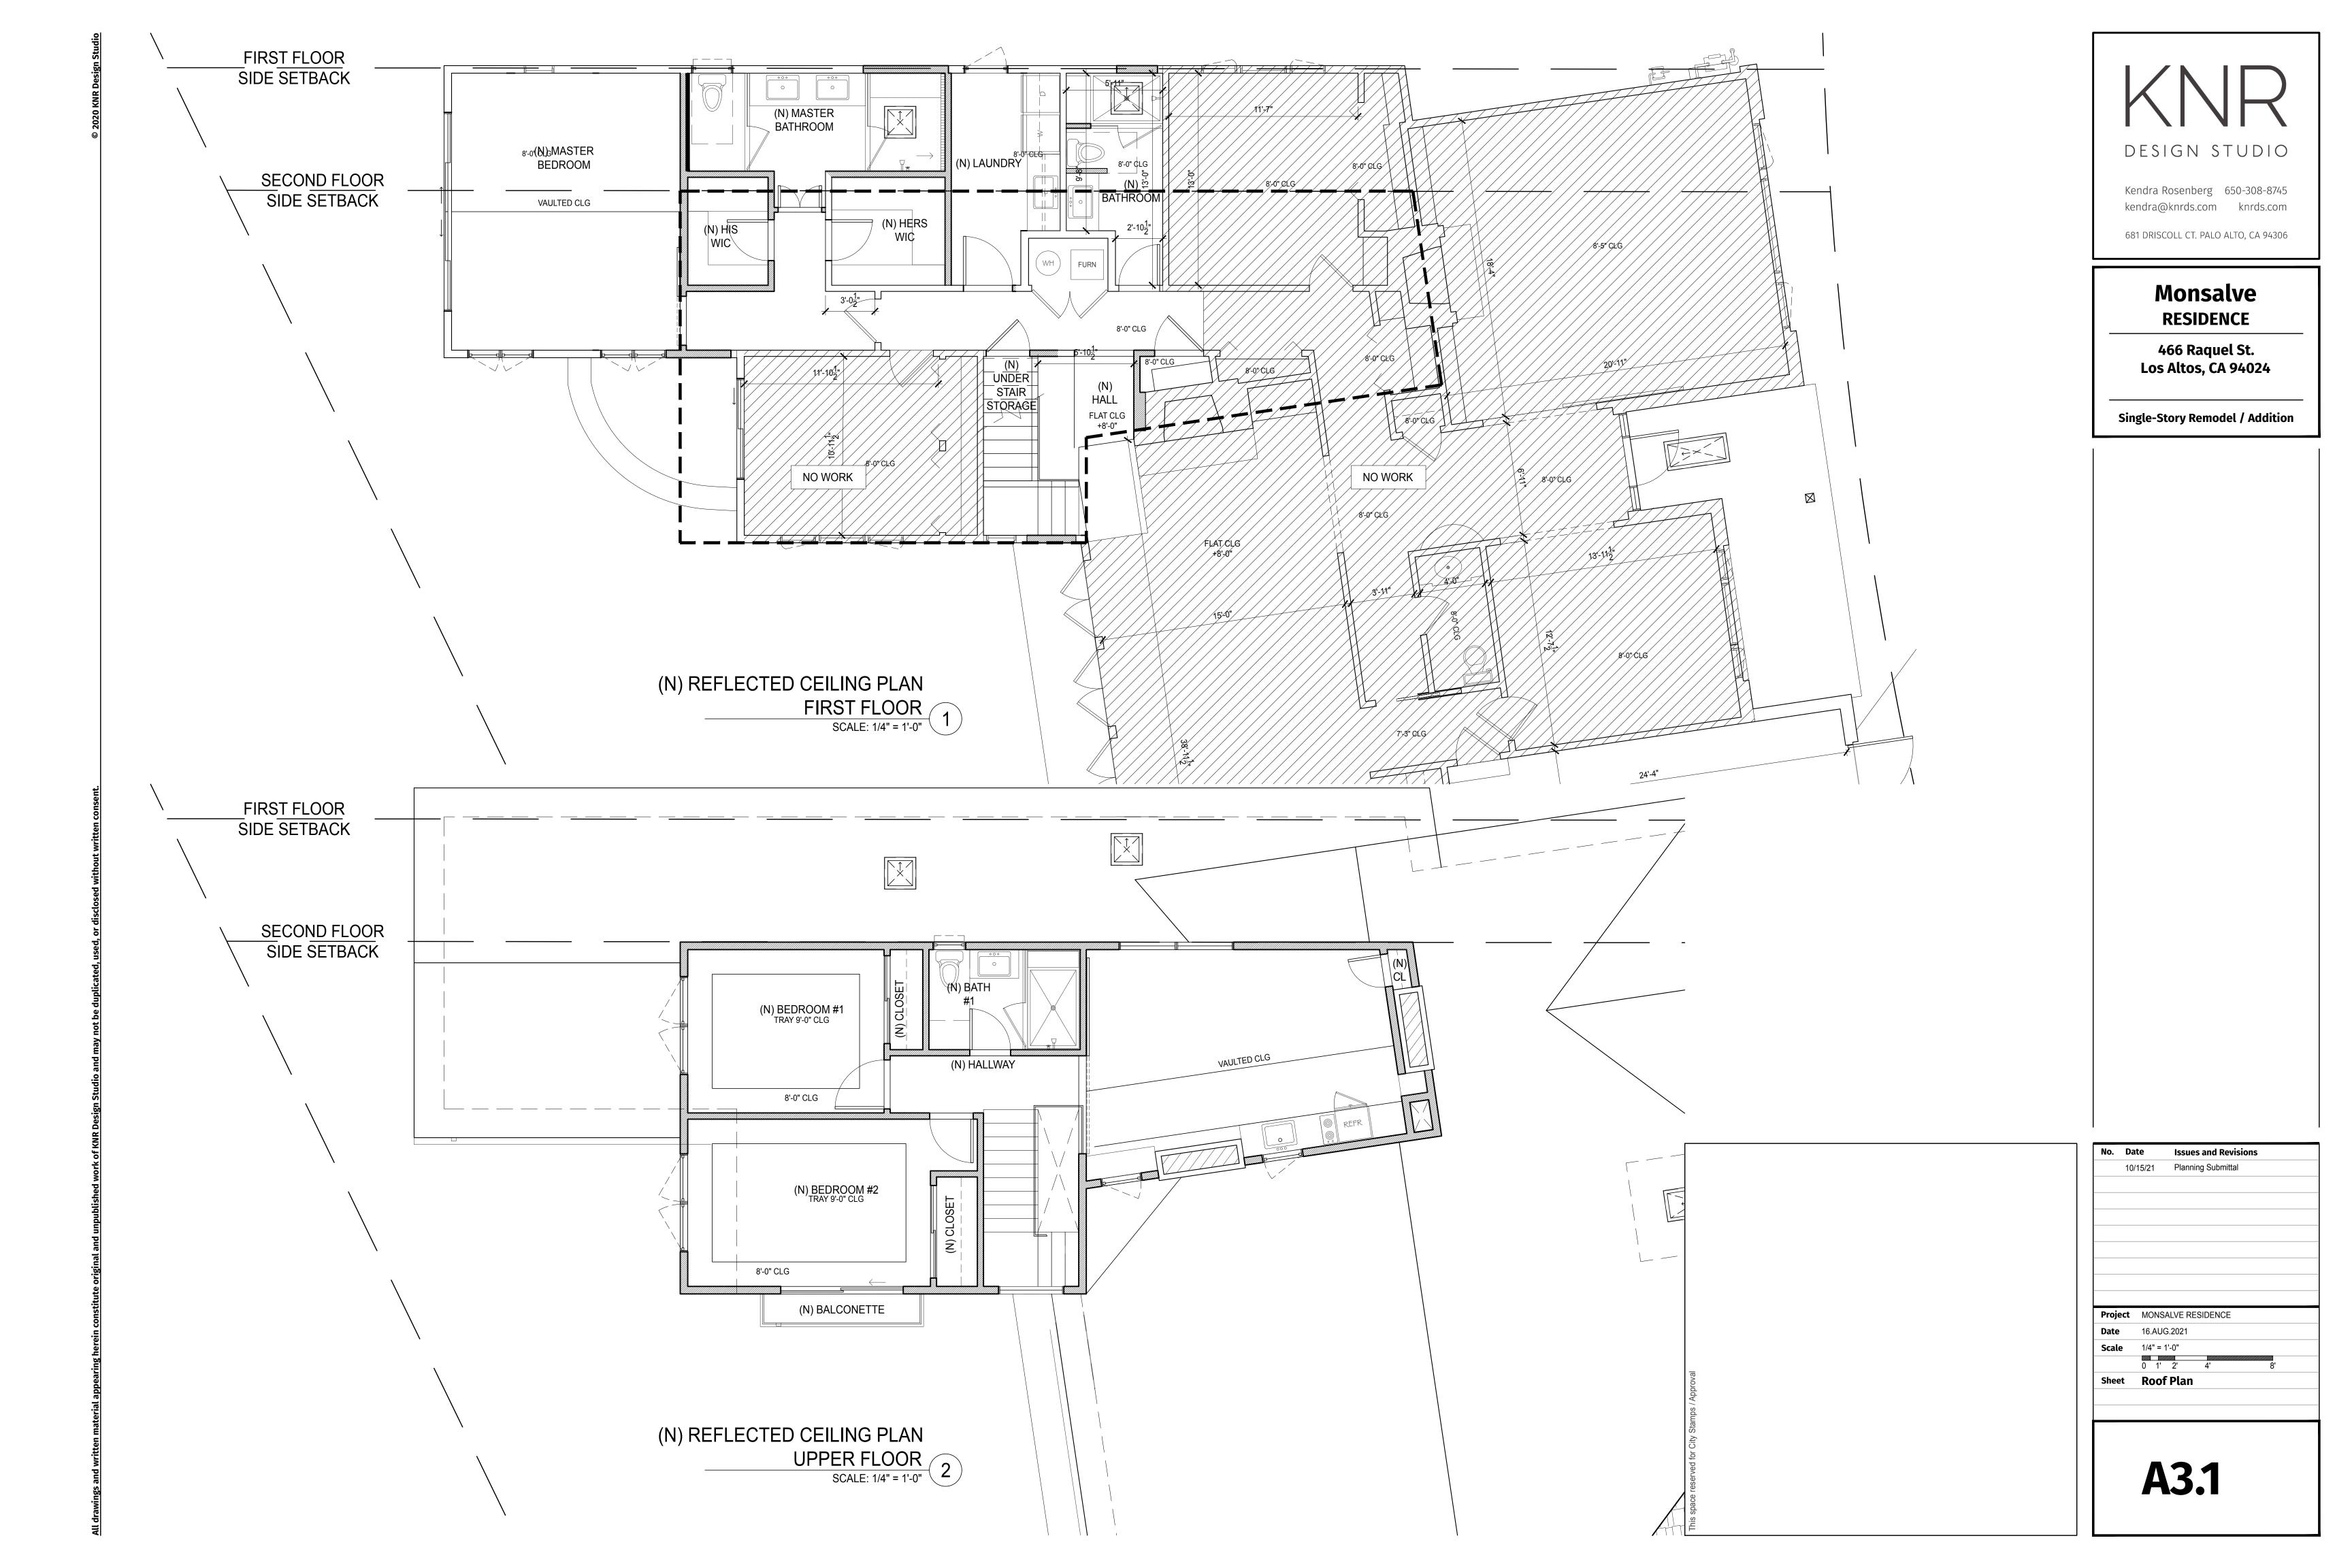
Single-Story Remodel / Addition




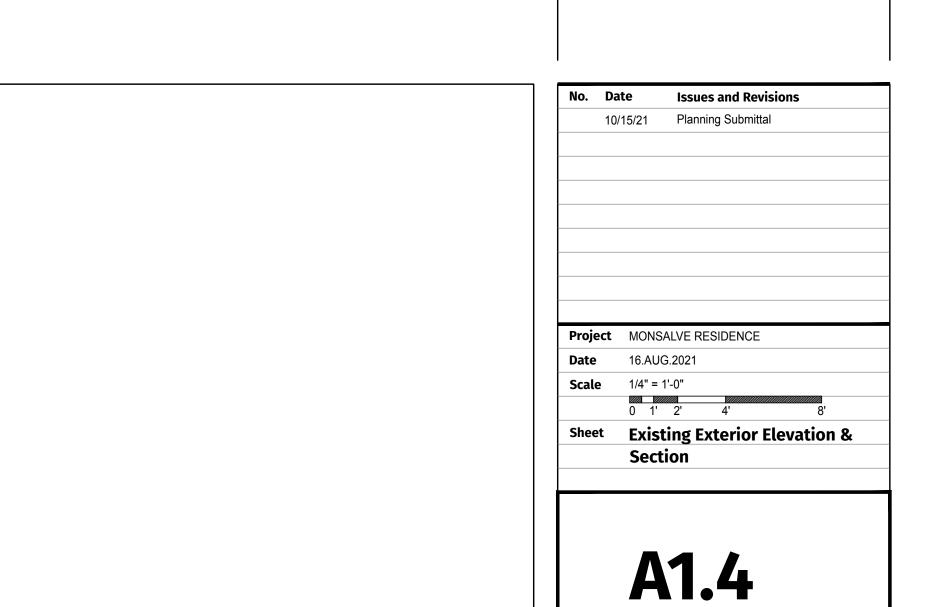


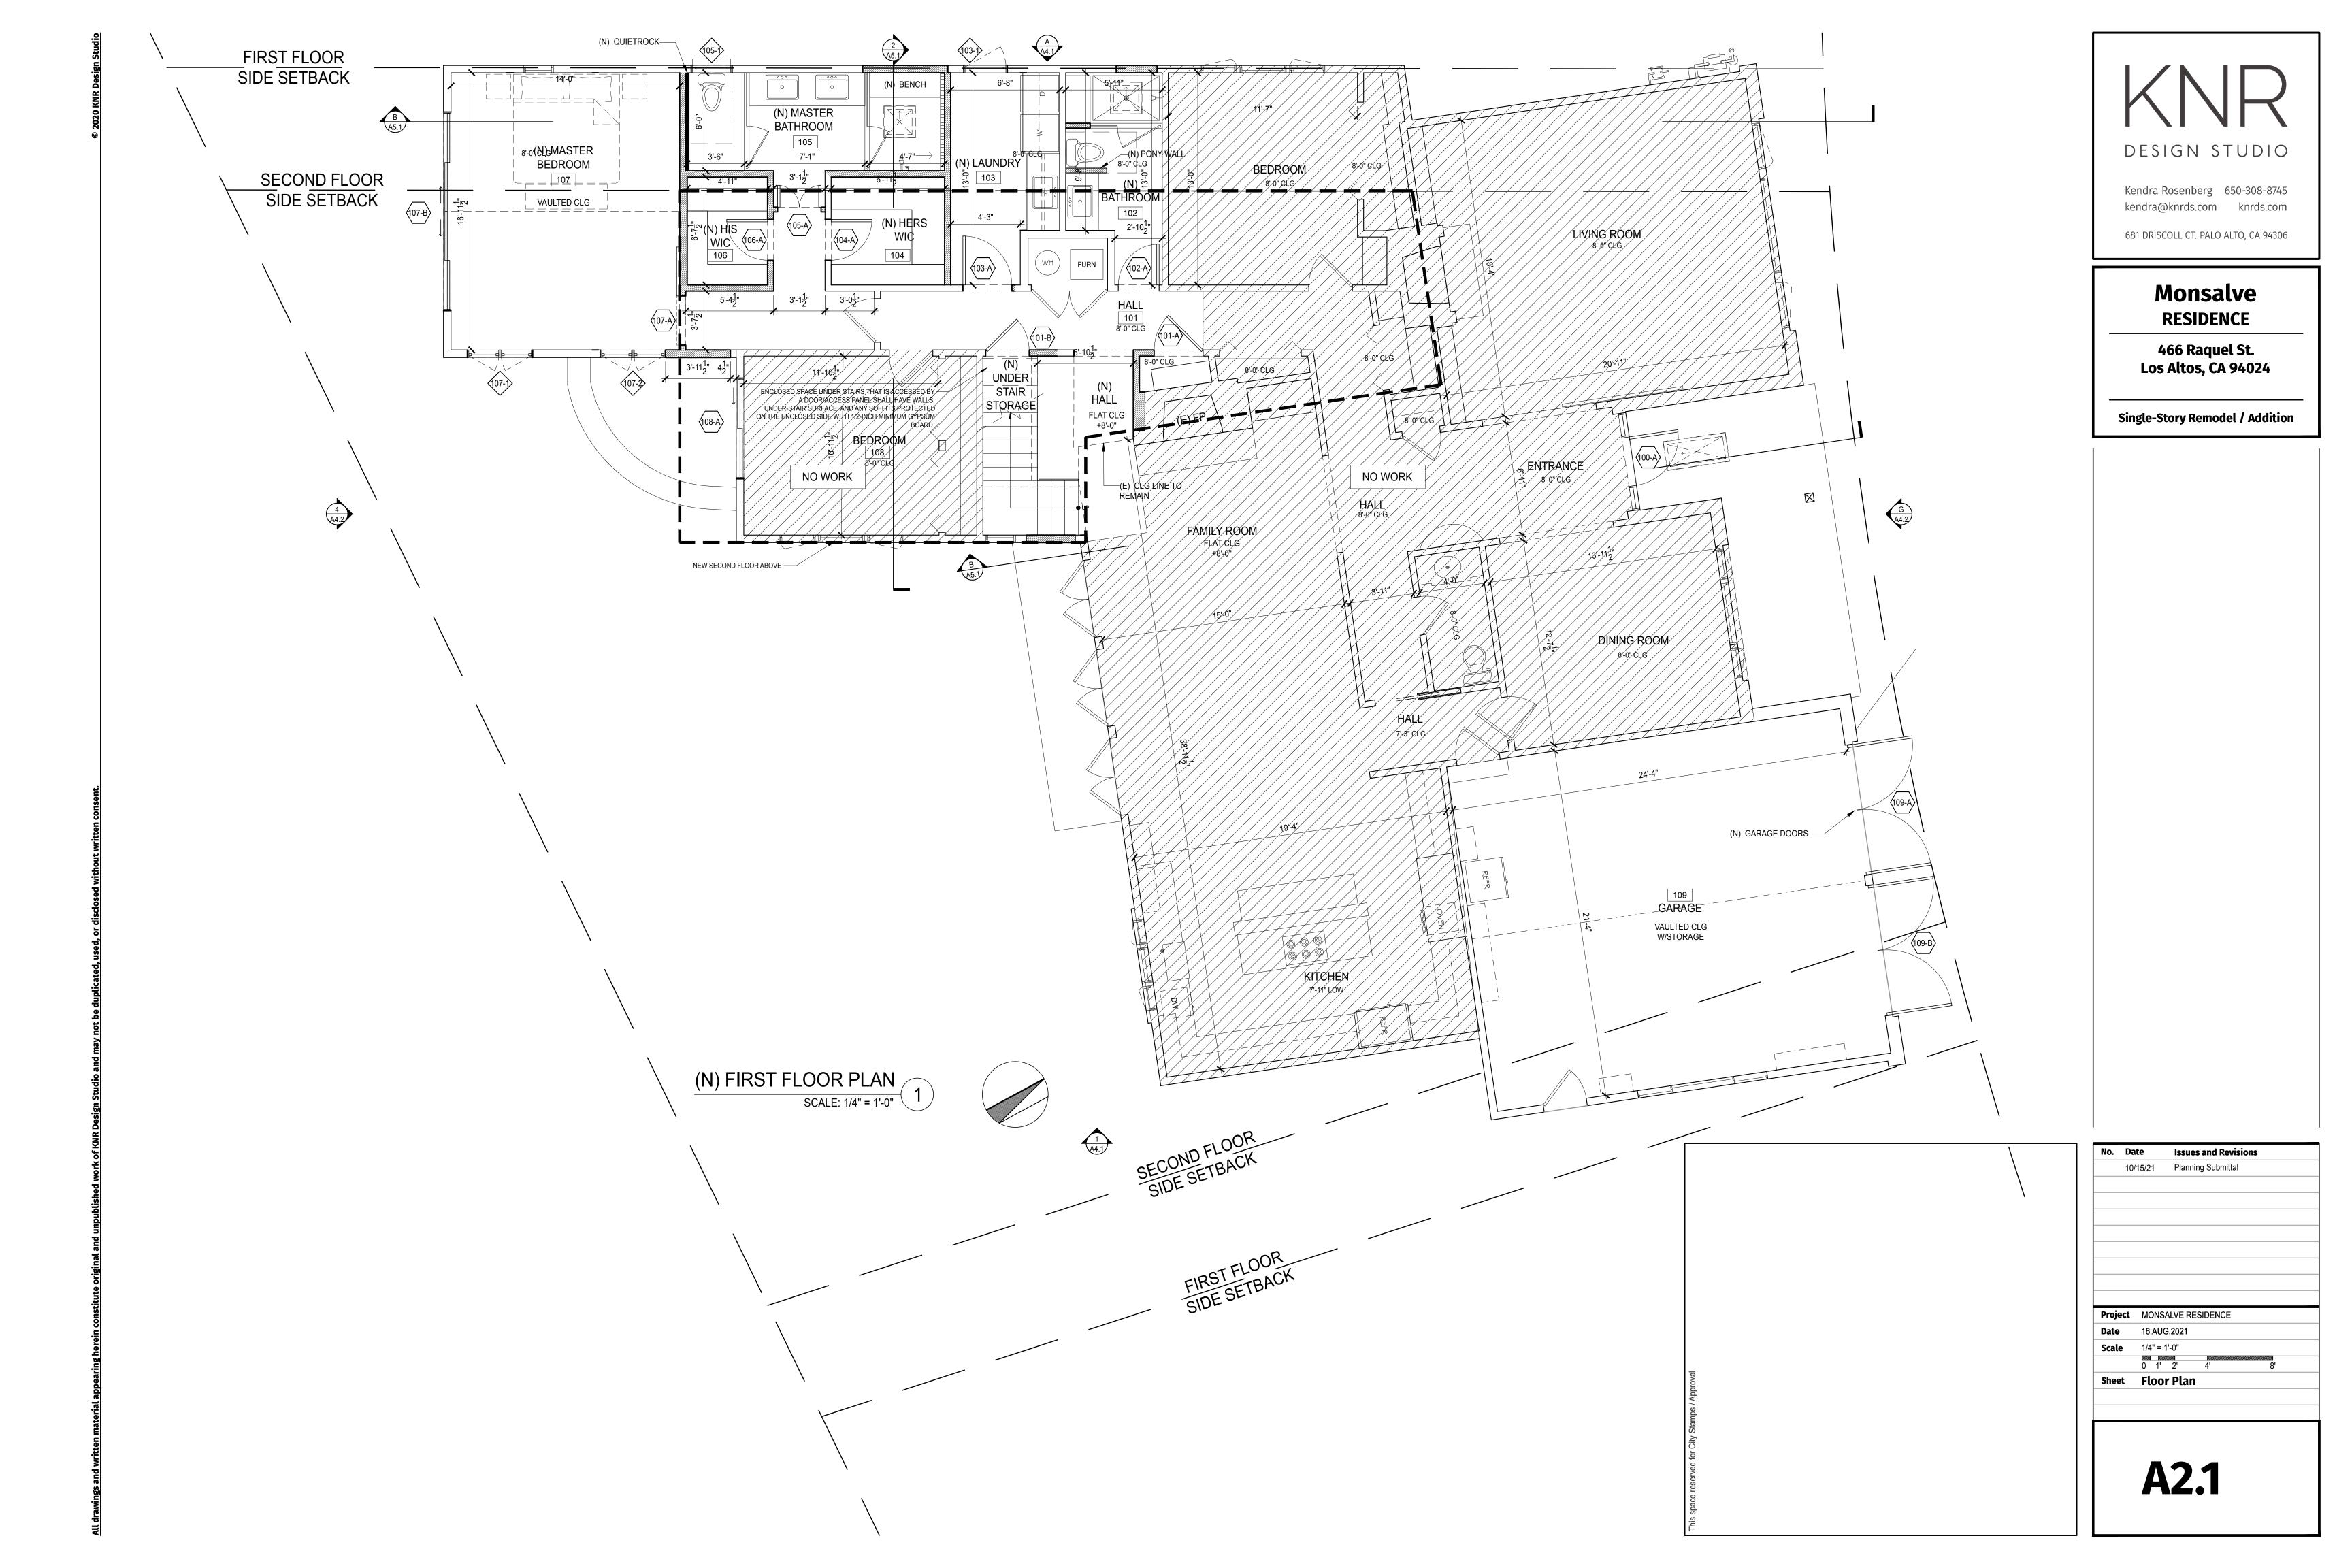


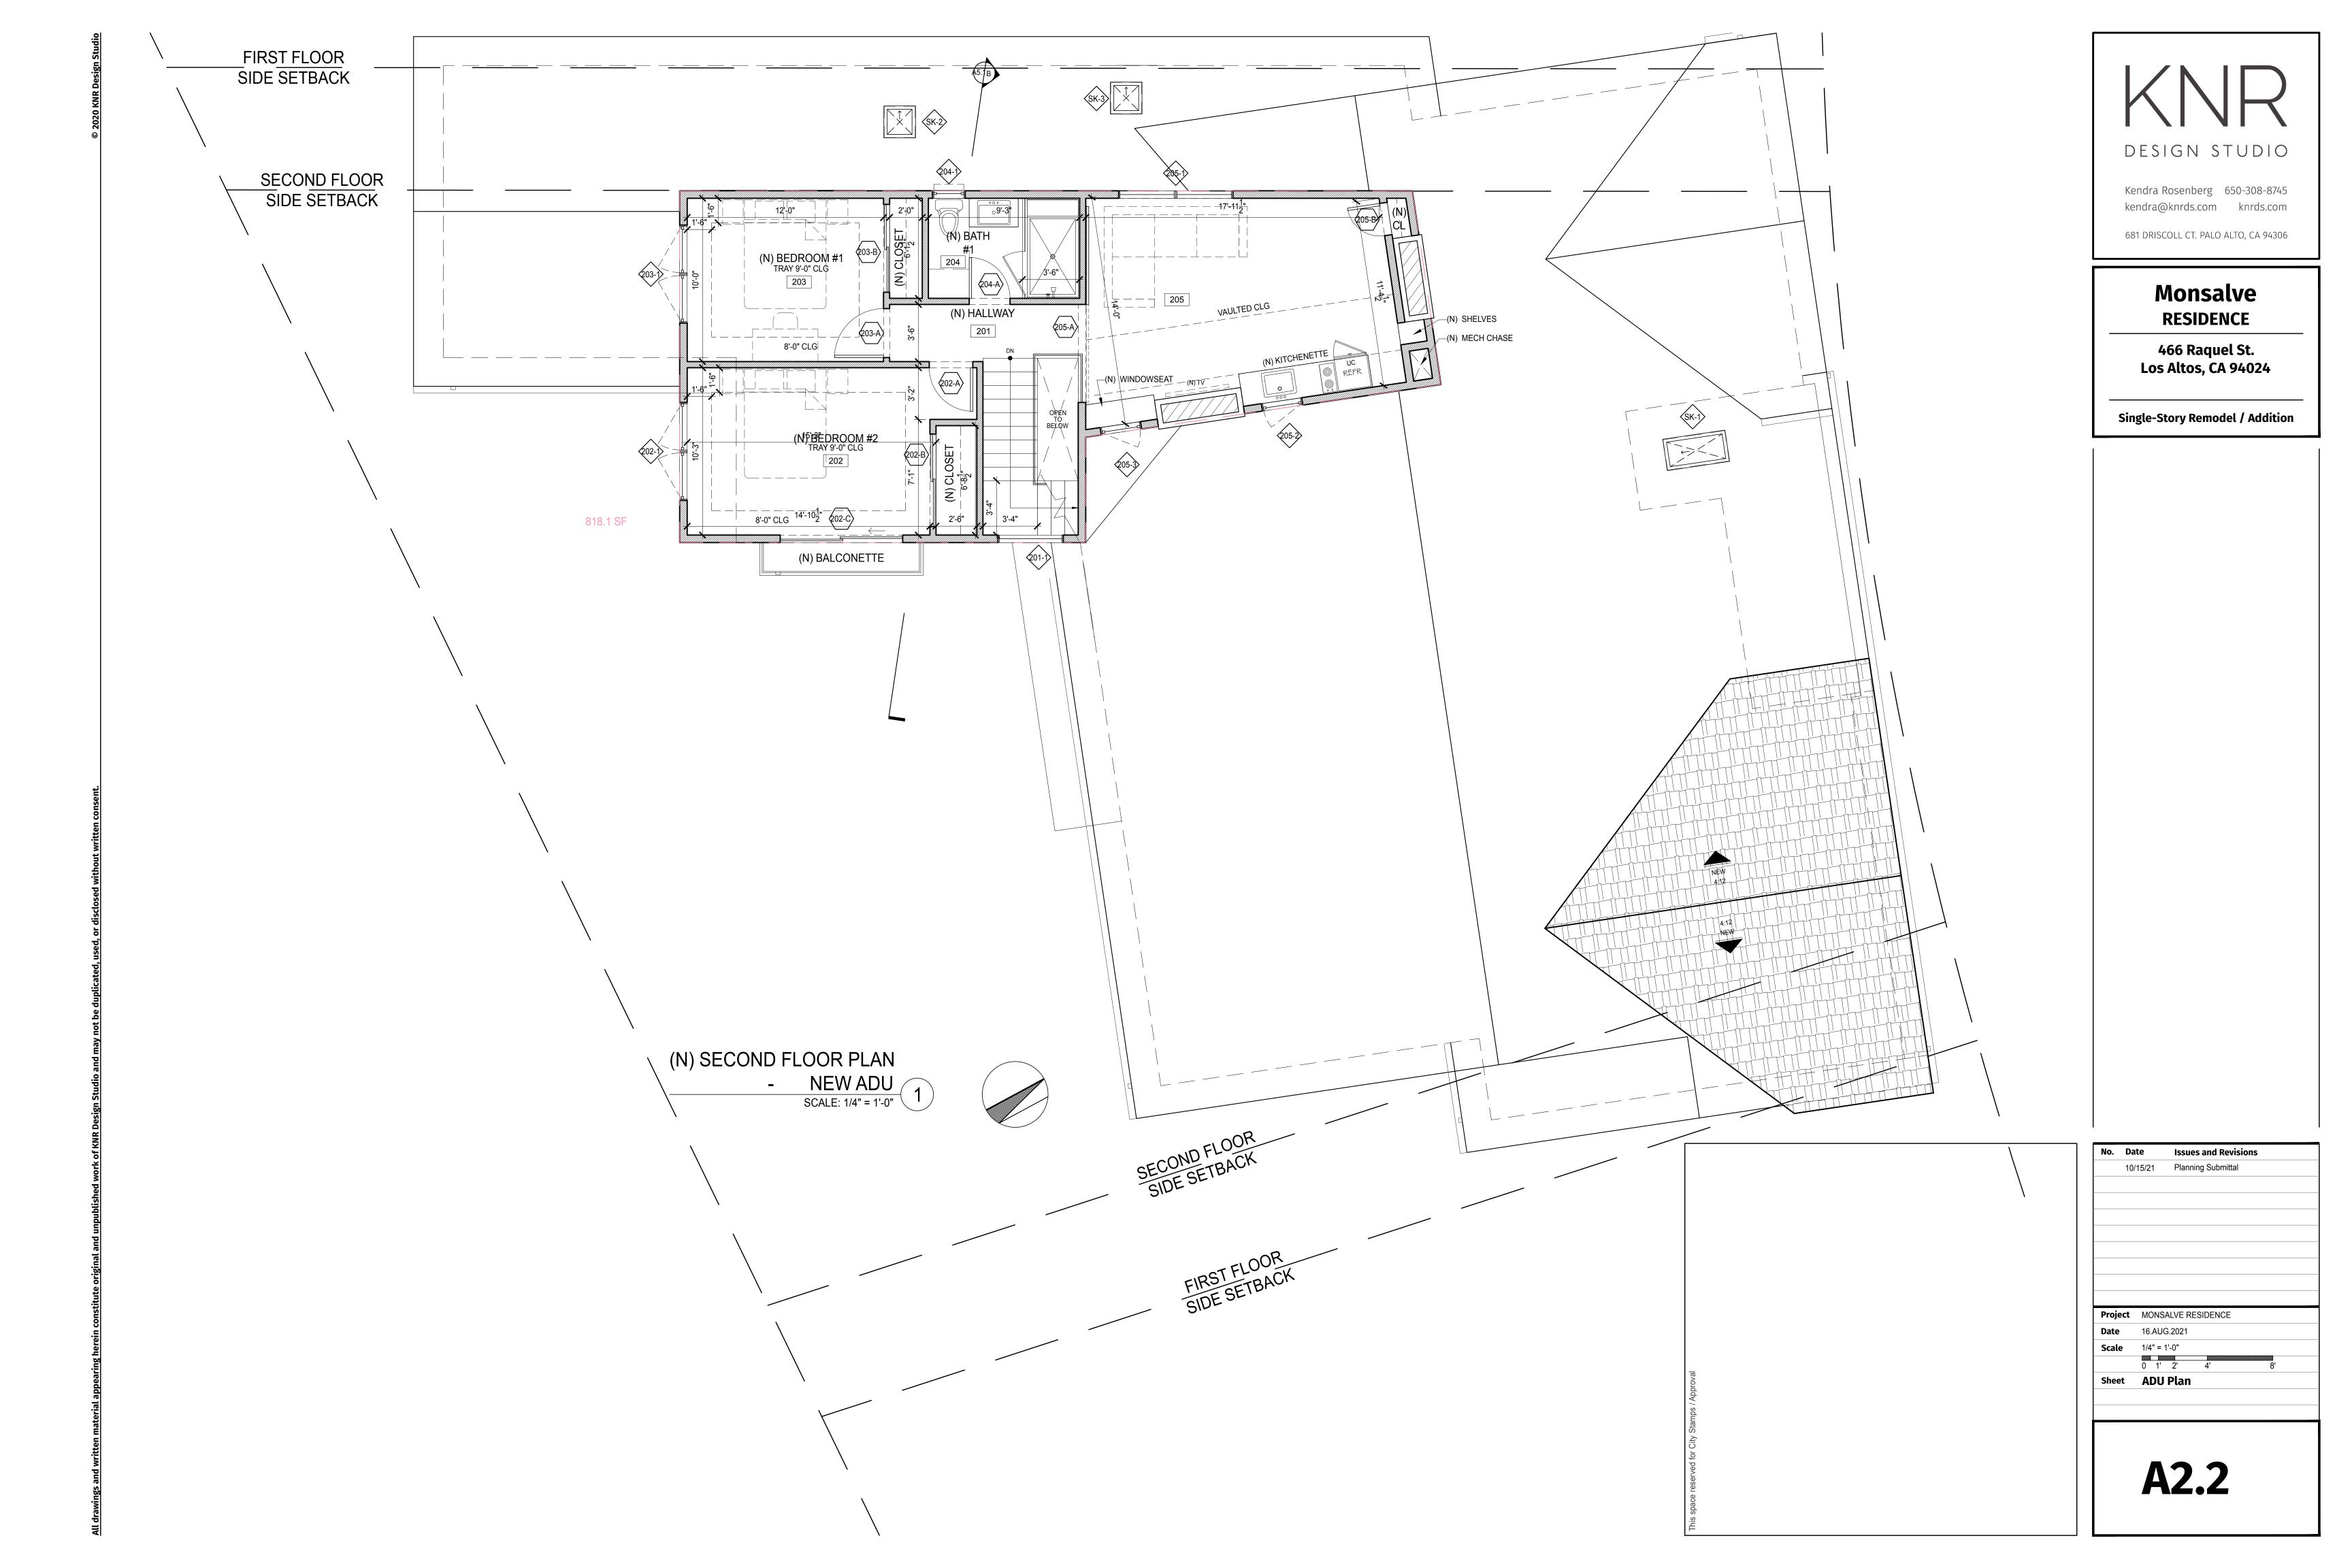

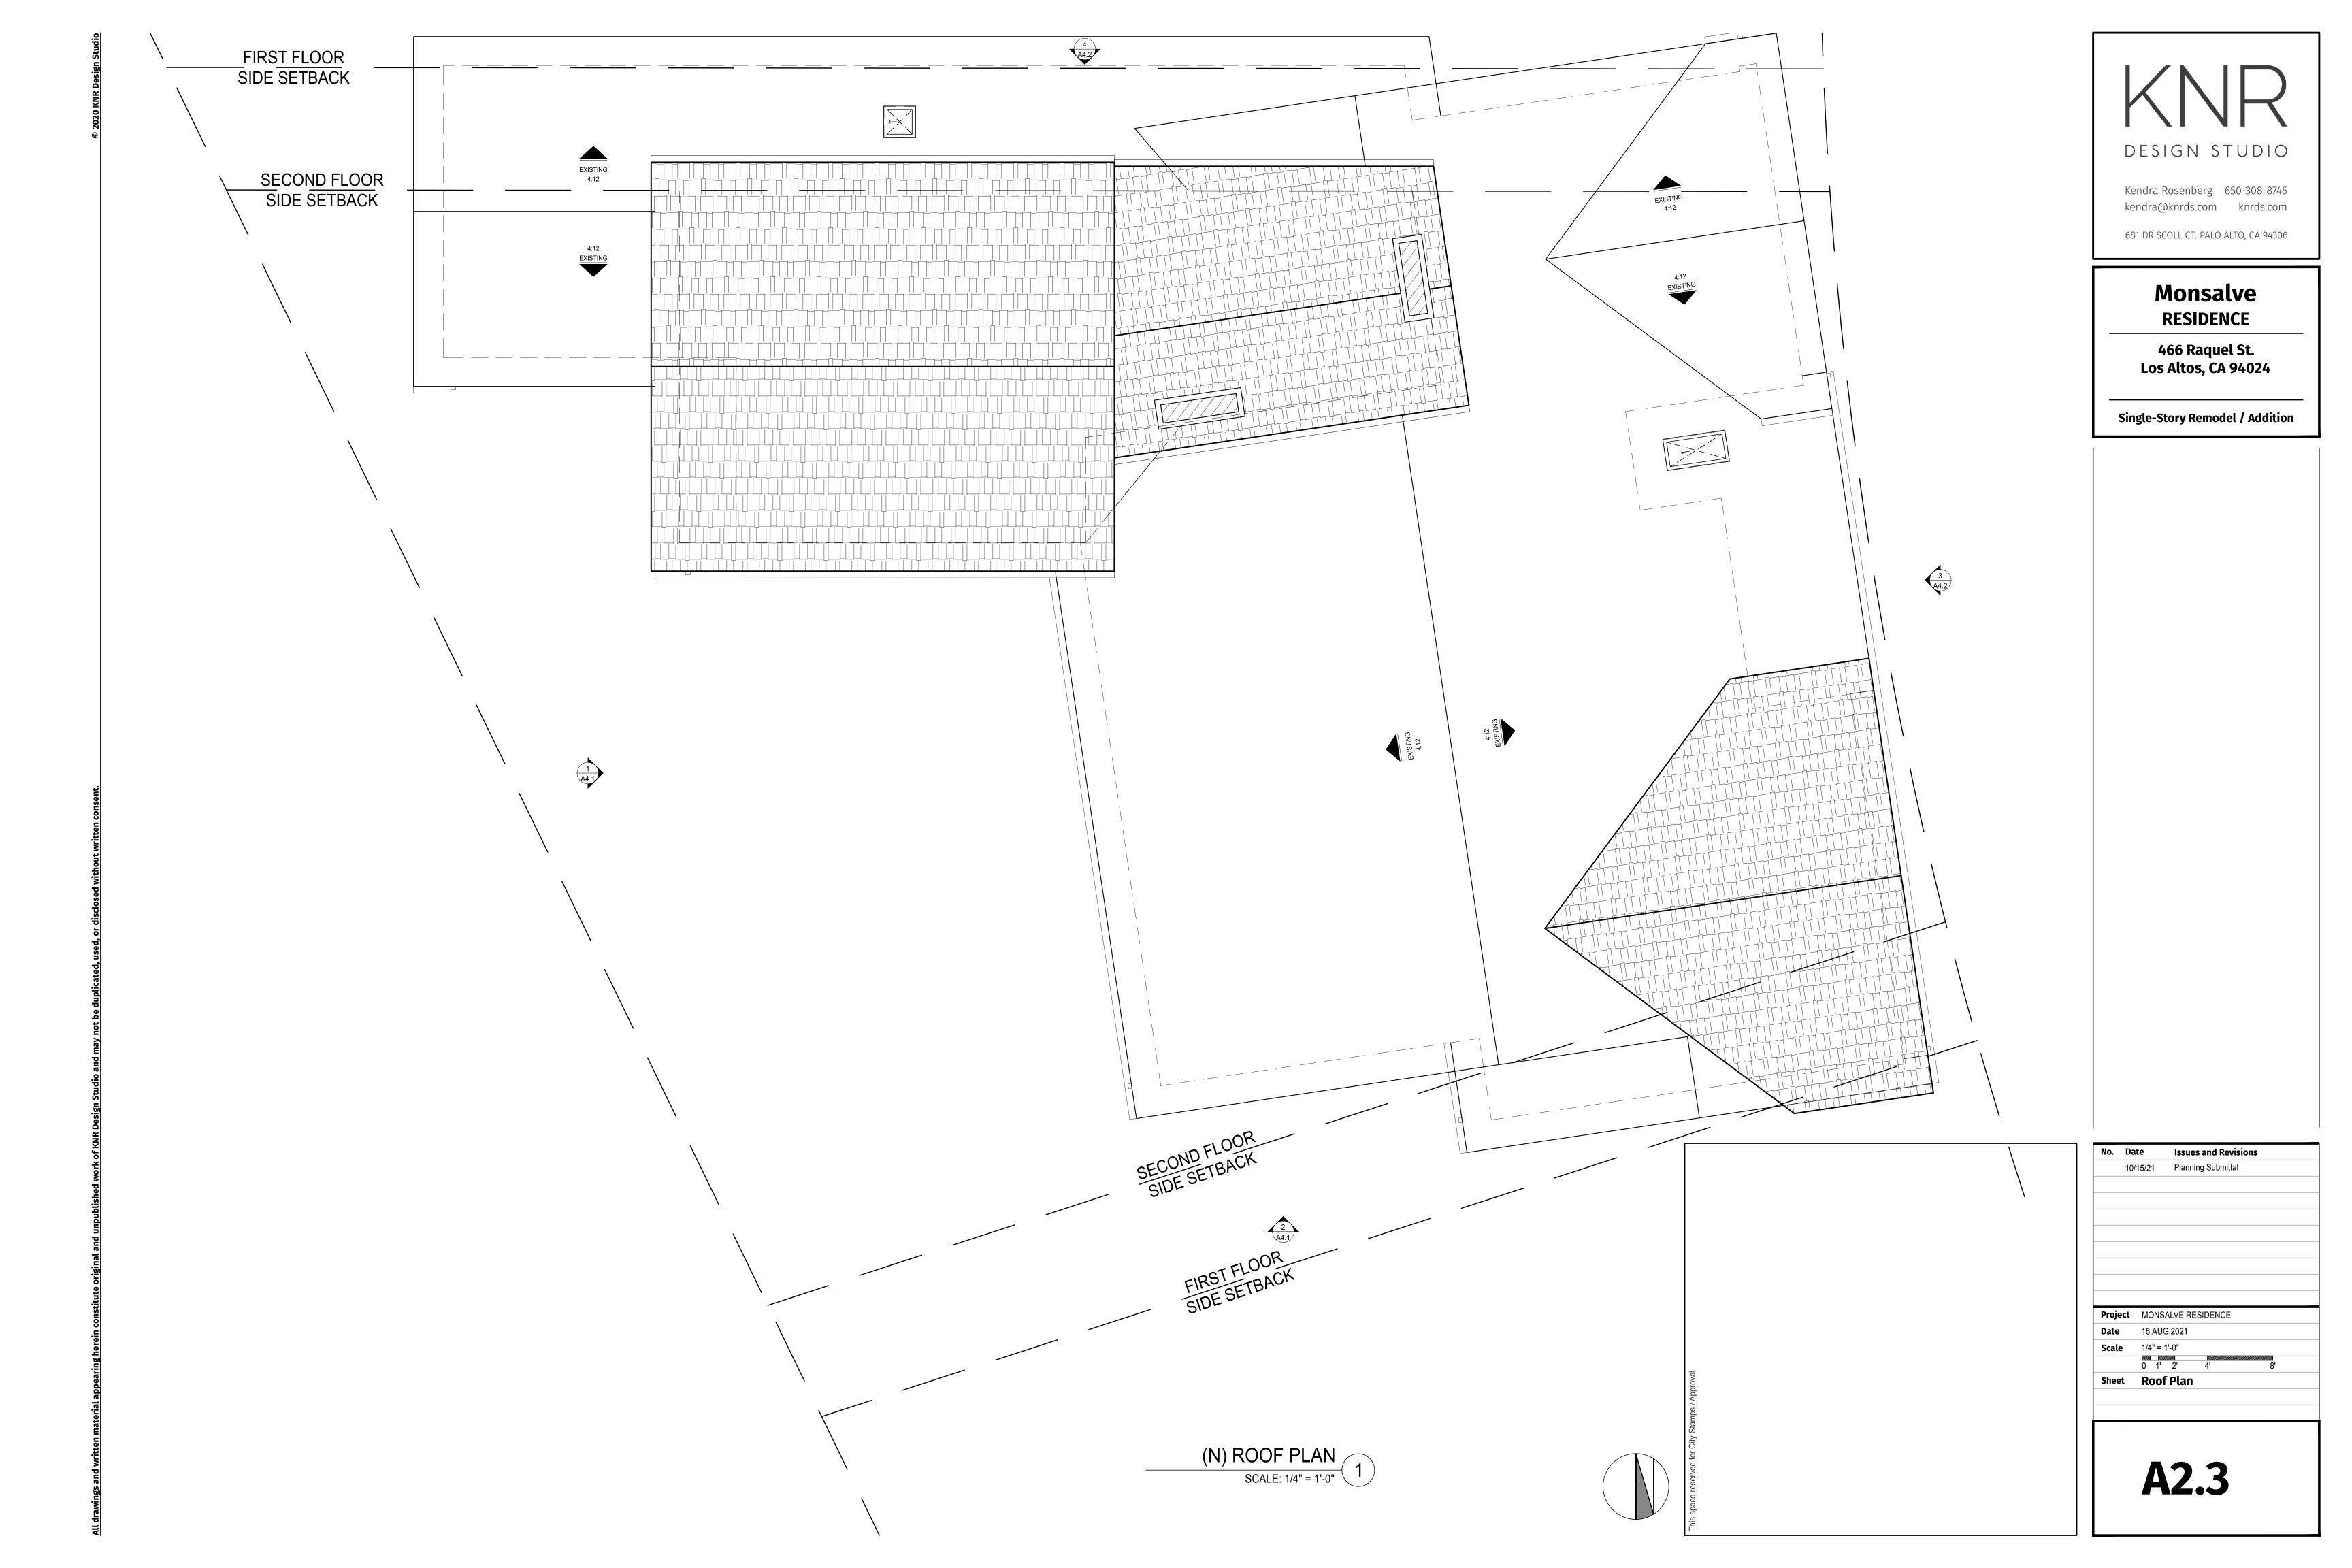

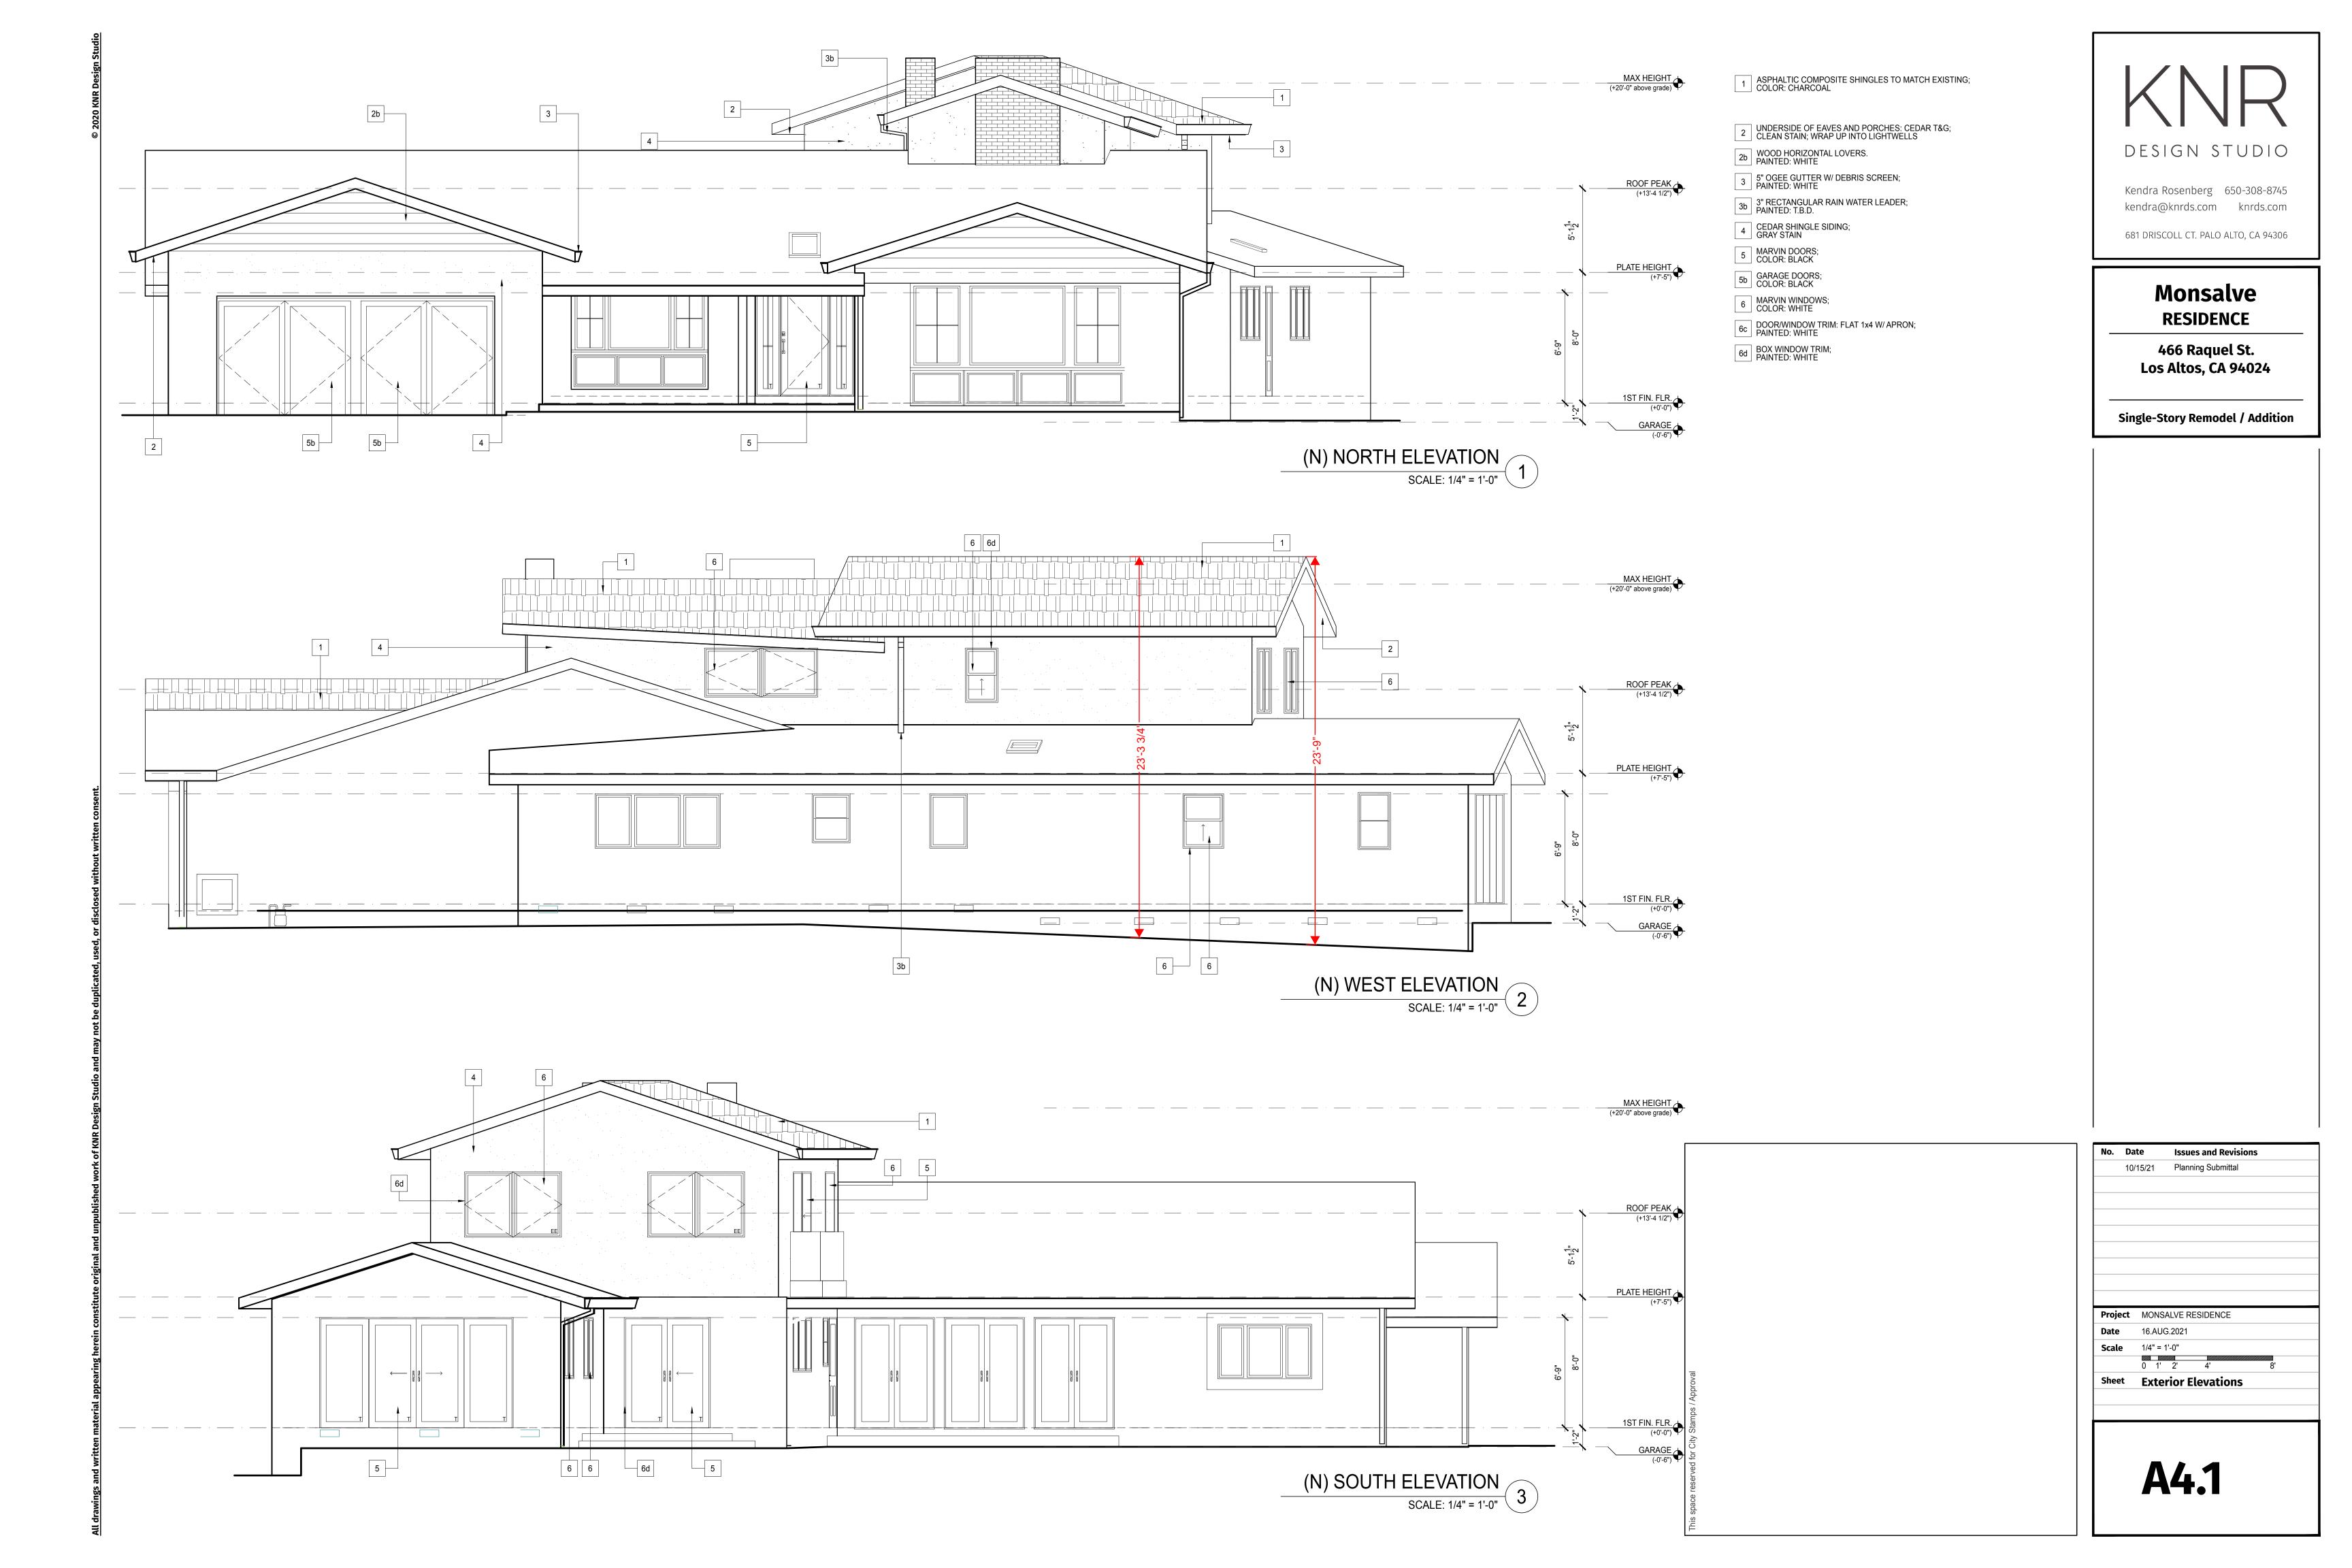

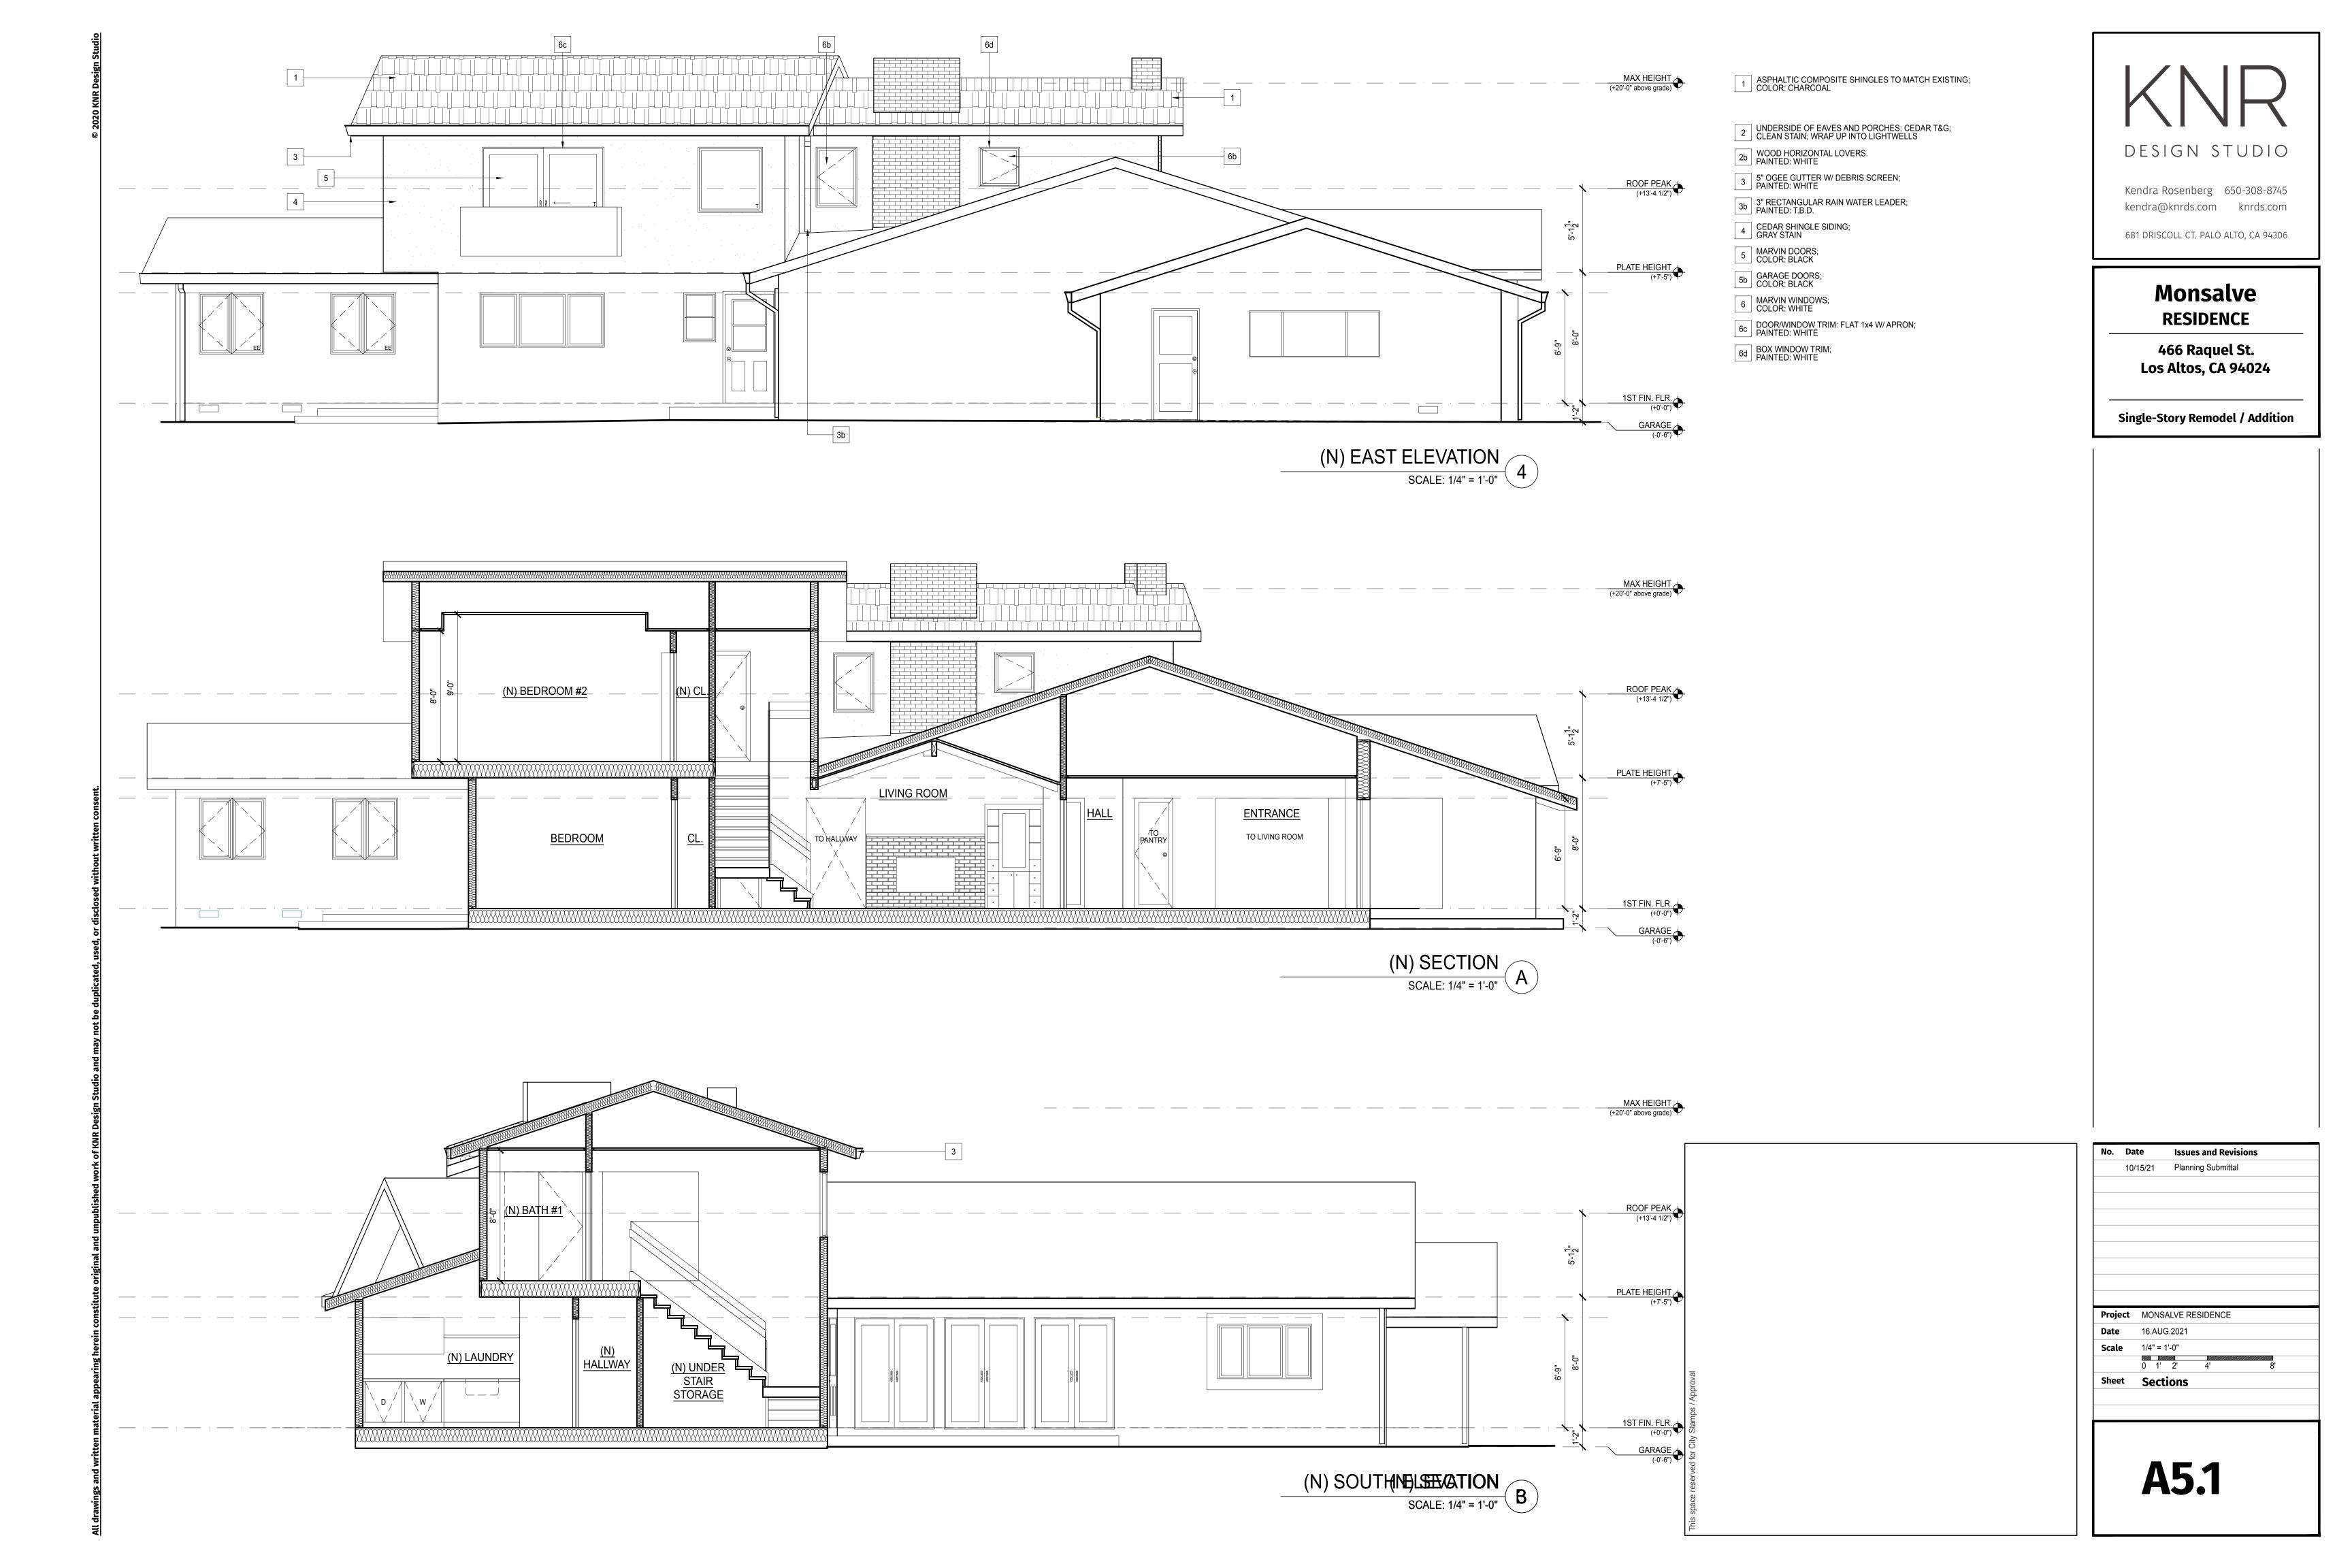

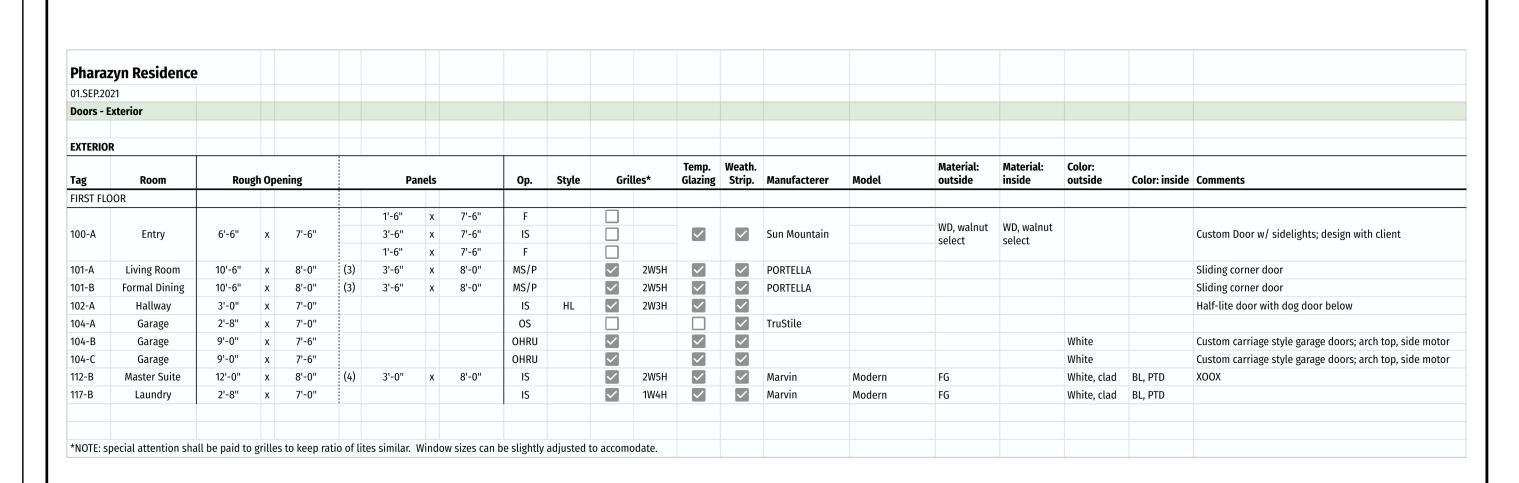

Pharaz	zyn Residence																	
01.SEP.20	21																	
Doors - I	nterior																	
EXTERIO	R																	
Tag	Room	Rou	gh Ope	ning			Panels		Op.	Style	Temp. Glazing	Fire Rated	Manufacterer	Model	Material	Color	Finish	Comments
FIRST FLO	OOR																	
102-B	Hallway	3'-0"	х	7'-0"					В						WD			Barn door
103-A	Storage	2'-8"	х	7'-0"					IS			~			WD			Self-closing
104-D	Garage	6'-0"	х	7'-0"	(2)	3'-0"	х	7'-0"	DSC						WD			
104-E	Garage	6'-0"	х	7'-0"	(2)	3'-0"	х	7'-0"	DSC						WD			
105-A	Guest Suite	2'-8"	х	7'-0"					IS						WD			
106-A	Guest Bath	2'-6"	х	7'-0"					IS						WD			
107-A	Powder	2'-8"	х	7'-0"					IS						WD			
110-A	Hallway	3'-0"	х	7'-0"					В						WD			Barn door
111-A	Bath #2	2'-6"	х	7'-0"					IS						WD			
111-B	Bath #2	2'-6"	х	7'-0"					PK						WD			
112-A	Master Suite	2'-8"	х	7'-0"					IS						WD			
113-A	Master Closet	2'-8"	х	7'-0"					IS						WD			
114-A	Master Bath	2'-8"	х	7'-0"					IS						WD			
114-B	Master Bath	2'-6"	х	7'-0"					IS						WD			
115-A	Bedroom #1	2'-6"	х	7'-0"					IS						WD			
115-B	Bedroom #1	4'-6"	х	7'-0"	(2)	2'-4"	х	7'-0"	SL						WD			
116-A	Bedroom #2	2'-6"	х	7'-0"					IS						WD			
116-B	Bedroom #2	4'-6"	х	7'-0"	(2)	2'-4"	Х	7'-0"	SL						WD			
117-A	Laundry	2'-8"	х	7'-0"					IS		~				WD			obscure glass inlay

hara	yn Residence																				
SEP.20	-																				
ndow																					
g	Room	Rou	gh Ope	ning		Nomina	al Opei	ning	Op.	Gri	lles*	Emerg. Egress	Temp. Glazing	Obsc. Glazing	Manufacterer	Model	Material: outside	Material: inside	Color: outside	Color: inside	Comments
RST FLO	OOR																				
1-1	Living	8'-0"	Х	4'-6"	(2)	4'-6"	Х	4'-6"	А	✓	3W3H		~		Marvin	Modern	FG	WD	White, clad	BL, PTD	
-2	Living	3'-0"	X	4'-6''					F						Marvin	Modern	FG	₩Đ	White, clad	BL, PTD	
3	Living	3'-0"	Х	4'-6"					С	~	2W3H				Marvin	Modern	FG	WD	White, clad	BL, PTD	
4	Living	3'-0"	х	4'-6"					С	~	2W3H				Marvin	Modern	FG	WD	White, clad	BL, PTD	
5	Dormer	3'-0"	х	3'-0"					F	~	2W2H				Marvin	Modern	FG	WD	White, clad	BL, PTD	
-1	Storage	1'-10"	Х	4'-6"					С	~	1W3H				Marvin	Modern	FG	WD	White, clad	BL, PTD	
1	Garage	4'-6"	Х	1'-10"					F	/	3W1H		~		Marvin	Modern	FG	WD	White, clad	BL, PTD	
						2'-8"	х	4'-0"	С	~	2W3H	~			Marvin	Modern	FG	WD	White, clad	BL, PTD	
-1	Guest Suite	8'-0"	х	4'-6"		2'-8"	х	4'-0"	F	~	2W3H				Marvin	Modern	FG	WD	White, clad	BL, PTD	
						2'-8"	х	4'-0"	С	~	2W3H	~			Marvin	Modern	FG	WD	White, clad	BL, PTD	
ı	Master Suite	1'-10"	Х	4'-6"					С	<u> </u>	1W3H	~			Marvin	Modern	FG	WD	White, clad	BL, PTD	
2	Master Suite	1'-10"	Х	4'-6"					С	~	1W3H	~			Marvin	Modern	FG	WD	White, clad	BL, PTD	
3	Master Suite	6'-0"	х	4'-6"	(2)	3'-0"	х	4'-6"	С	<u> </u>	2W3H	~			Marvin	Modern	FG	WD	White, clad	BL, PTD	
4	Master Suite (high)	12'-0''	X	2'-0"					F						Marvin	Modern	FG	₩Đ	White, clad	BL, PTD	Window above 112-B master suite exterior door
-1	Bedroom #1	6'-0"	Х	4'-6"	(2)	3'-0"	Х	4'-6"	С	✓	2W3H	~	~	$\overline{\Box}$	Marvin	Modern	FG	WD	White, clad	BL, PTD	
-1	Bedroom #2	6'-0"	Х	4'-6"	(2)	3'-0"	х	4'-6"	С	~	2W3H	<u> </u>	<u> </u>	$\overline{\Box}$	Marvin	Modern	FG	WD	White, clad	BL, PTD	
_IGH											nting										
	Patio	1'-9"	х	3'-17/8"					F		urb			П	Velux	FCM 1430					
	Patio	1'-9"		3'-17/8"					F		ırb			ī	Velux	FCM 1430					
	Patio	1'-9"		3'-17/8"					F		ırb		n	ī	Velux	FCM 1430					
	Kitchen	3'-8 1/4"		2'-2 7/8"					F		eck		n	$\overline{\Box}$	Velux	S01-F					
;	Powder	1'-10 1/2"		1'-10 15/16"					F		eck		n	<u></u>	Velux	D26					WHITE LAMINATE
	Guest Bath			1'-10 15/16"					F		eck	- H	n	✓	Velux	D26					WHITE LAMINATE
	Master Closet			1'-10 15/16"					F		eck		T T	✓	Velux	D26					WHITE LAMINATE
}	Master Bath			1'-10 15/16"					F		eck			· /	Velux	D26					WHITE LAMINATE
9	Master Bath			1'-10 15/16"					F		eck				Velux	D26					Wet location (shower)
0	Master Bath (WC)	1'-9"		2'-2 7/8"					F		eck			✓	Velux	C01-V					WHITE LAMINATE, operable switch
1	Bath #2		-	1'-10 15/16"					F .		eck			✓	Velux	D26					WHITE LAMINATE
<u>'</u> 2	Bath #2			1'-10 15/16"	-				F		eck			✓	Velux	D26					WHITE LAMINATE
3	Bath #2 (WC)	1'-9"		2'-2 7/8"					'		eck			✓	Velux	C01-V					WHITE LAMINATE, operable switch
	Datil #2 (VVC)	I ⁻ 2	^	2 2110					1 '	ue	LCN			V	VELUA	COT-V					with a community operable switch

01.SEP.2	nzyn Residence	
	021	
KEY		
Abb.	Full	Comments
A	Awning	
ACWD	Aluminum Clad Wood	
В	Barn door	
BF	Bi-folding	
С	Casement	
CAR	Carriage (garage door)	
DH	Double Hung	
DFR	Double French	
DSC	Double swinging Closet	
F	Fixed	
FG	Fiberglass	
FR	French (swinging)	
FRSL	French sliding	
HL	Half-lite	
IS	In-swinging	
L&S	Lift-and-Slide	
MS	Multi-slide	
OHRU	Overhead Roll-Up	
OS	Out-swinging	
PK	Pocket	
PTD	Painted	
PV	Pivot	
S	Swinging	
SCW	Solid core wood	
SL	Sliding	
T	Terrace	
VIF	Verify in field	

proval			
This space reserved for City Stamps / Approval			
City Sta			
erved for			
bace resi			
This sp			

K	1R
DESIGN	STUDIO

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681 DRISCOLL CT. PALO ALTO, CA 94306

Monsalve RESIDENCE

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Single-Story Remodel / Addition

No. Date Issues and Revisions

10/15/21 Planning Submittal

Project MONSALVE RESIDENCE

Date 16.AUG.2021

Scale 1/4" = 1'-0"

0 1' 2' 4' 8'

Sheet Door/Window Schedule

A6.1